COMPONENTS OF CONTRACT PLANS SET ROADWAY PLANS

A DETAILED INDEX APPEARS ON THE KEY SHEET OF EACH COMPONENT

INDEX OF ROADWAY PLANS

SHEET DESCRIPTION


- KEY SHEET 1
- 2 SUMMARY OF PAY ITEMS
- 3 TYPICAL SECTIONS
- Δ NOT USED
- 5 GENERAL NOTES
- ROADWAY PLAN SHEETS 6-9
- STUDENT ENTRANCE DETAILS 10
- 11 NOT USED
- 12-18 CROSS SECTIONS
- 19-20 STORMWATER POLLUTION PREVENTION PLAN
- 21 MAINTENANCE OF TRAFFIC
- 22 NOT USED
- SIGNING AND PAVEMENT MARKING GENERAL NOTES 23
- SIGNING AND PAVEMENT MARKING PLANS 24-25

Beginning of Project

STA. 40+89.98


VILLAGE OF ESTERO


CONTRACT PLANS

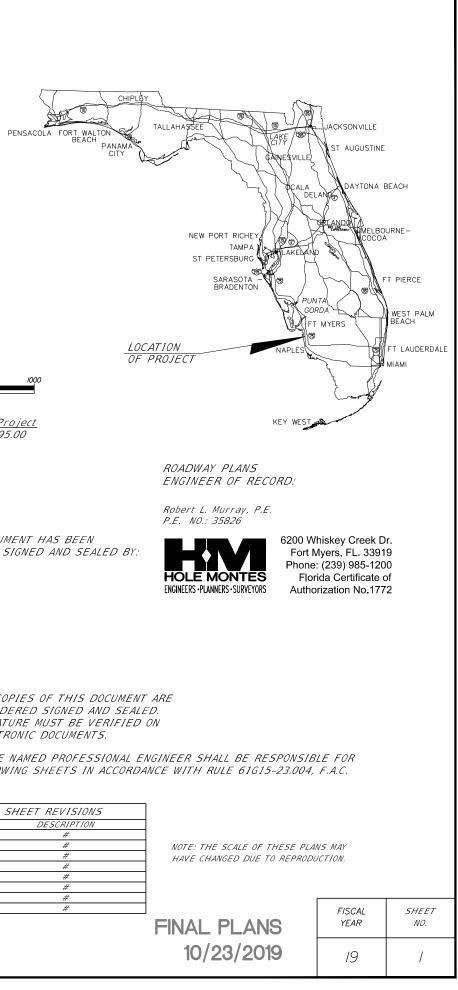

WILLIAMS ROAD TURN LANE IMPROVEMENTS & BUFFER BIKE LANES

VILLAGE OF ESTERO PROJECT NO. LEE COUNTY, FLORIDA

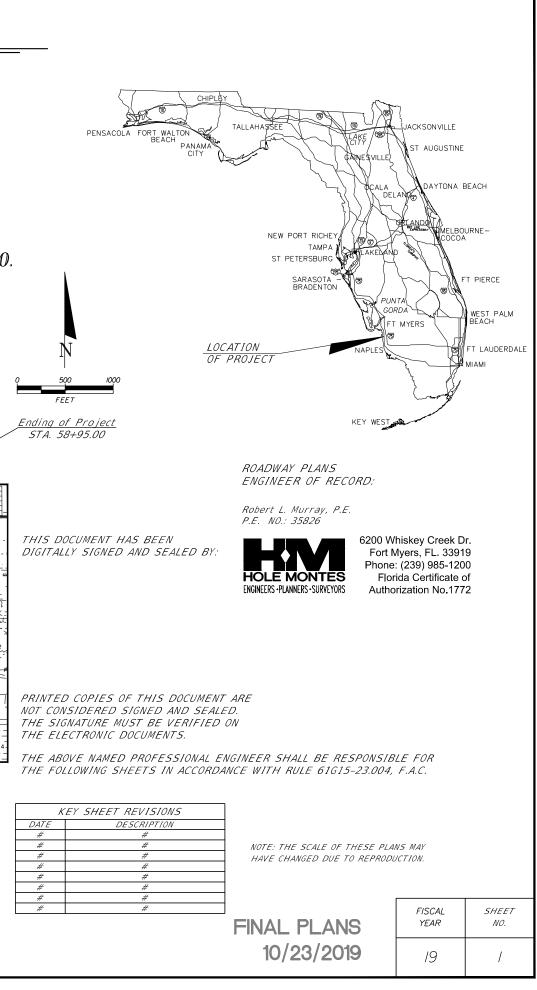

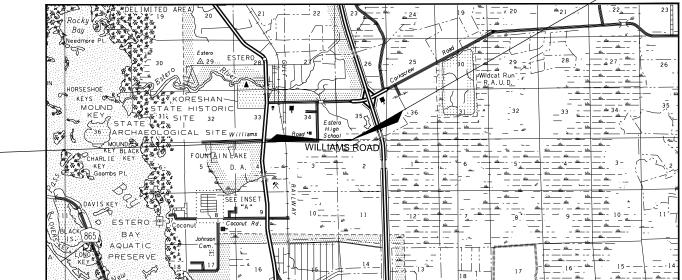

REVISIONS:

GOVERNING STANDARD PLANS:

Florida Department of Transportation, FY2019-20 Design Standards for Road and Bridge Construction and applicable interim Revisions (IRs)

Standard Plans for Road Construction and associated IRs are available at the following website: http://www.fdot.gov/design/standardplans

GOVERNING STANDARD SPECIFICATIONS:

Florida Department of Transportation, Jan. 2019 Standard Specifications for Road and Bridge Construction at the following website: http://www.fdot.gov/programmanagement/implemented/SpecBooks


PROJECT SUMMARY OF PAY ITEMS			
ITEM NUMBER	ITEM DESCRIPTION	UNITS	QUANTIT
101-1	MOBILIZATION	LS	1
102-1	MAINTENANCE OF TRAFFIC	LS	1
104-10-3	SEDIMENT BARRIER	LF	4290
110-1-1	CLEARING AND GRUBBING	AC	3.0100
110-4-10	REMOVAL OF EXISTING CONCRETE	SY	261
120-1	REGULAR EXCAVATION	СҮ	1158
120-6	EMBANKMENT	СҮ	580
160-4	TYPE B STABILIZATION	SY	5967
285-706	OPTIONAL BASE, BASE GROUP 6	SY	153
285-707	OPTIONAL BASE, BASE GROUP 7	SY	4610
327-70-1	MILLING EXISTING ASPHALT PAVEMENT (1" AVG. DEPTH)	SY	5461
331-2-1	ASPHALTIC CONCRETE S-1	ΤN	494
331-2-2	ASPHALTIC CONCRETE S-3	ΤN	603
520-3	2.0' VALLEY GUTTER	LF	77
520-70	CONCRETE TRAFFIC SEPERATOR, SPECIAL-VARIABLE WIDTH	SY	24
522-2	CONCRETE SIDEWALK, 6" THICK	SY	234
527-2	DETECTABLE WARNING (INSET/WET SET TYPE)	SF	64
570-1-2	PERFORMANCE TURF, SOD	SY	4130
SP-1	COURSE AGGREGATE	LS	1

PROJECT SUMMARY OF PAY ITEMS			
ITEM NUMBER	ITEM DESCRIPTION	UNITS	QUANTITY
700-1-11	SINGLE POST SIGN, F & I, GROUND MOUNT, UP TO 12 SF.	AS	2
700-1-50	SINGLE POST SIGN, RELOCATE	AS	1
700-1-60	SINGLE POST SIGN, REMOVE, GROUND MOUNTED	AS	2
705-11-1	DELINEATOR, FLEXIBLE MOUNT	ΕA	1
706-3	RETRO-REFLECTIVE PAVEMENT MARKER	EA	247
710-11-19	ISLAND NOSING, PAINT, WHITE	SF	7
711-11-101	THERMOPLASTIC, STD, WHITE, SOLID 6"	GM	0.8400
711-11-123	THERMOPLASTIC, STD, WHITE, SOLID, 12"	LF	282
711-11-125	THERMOPLASTIC, STD, WHITE, SOLID, 24"	LF	47
711-11-201	THERMOPLASTIC, STD, YELLOW, SOLID, 6"	GM	1.0900
711-11-224	THERMOPLASTIC, STD, YELLOW, SOLID, 18"	LF	404
711-14-170	THERMOPLASTIC, PREFORMED WHITE, ARROW	EA	15

NOTE: SP-1 COMPLETE INSTALLATION OF A 3'X3'X4" DEEP, #2 COURSE AGGREGATE (INCLUDING FILTER FABRIC, DIRT REMOVAL, ETC.)



WILLIAMS ROAD TURN LANE & PAVED SHOULDER IMPROVEMENTS

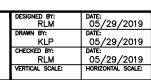




ROBERT L. MURRAY, P.E. P.E. NO.: 35826 HOLE MONTES, INC. 6200 WHISKEY CREEK DRIVE FORT MYERS, FL. 33919 CERTIFICATE OF AUTHORIZATION NO.1772

REVISIONS

SUMMARY OF	reference no. 18081	drawing no. SPP—1
PAY ITEMS	project no. 2018081	sheet no. 2

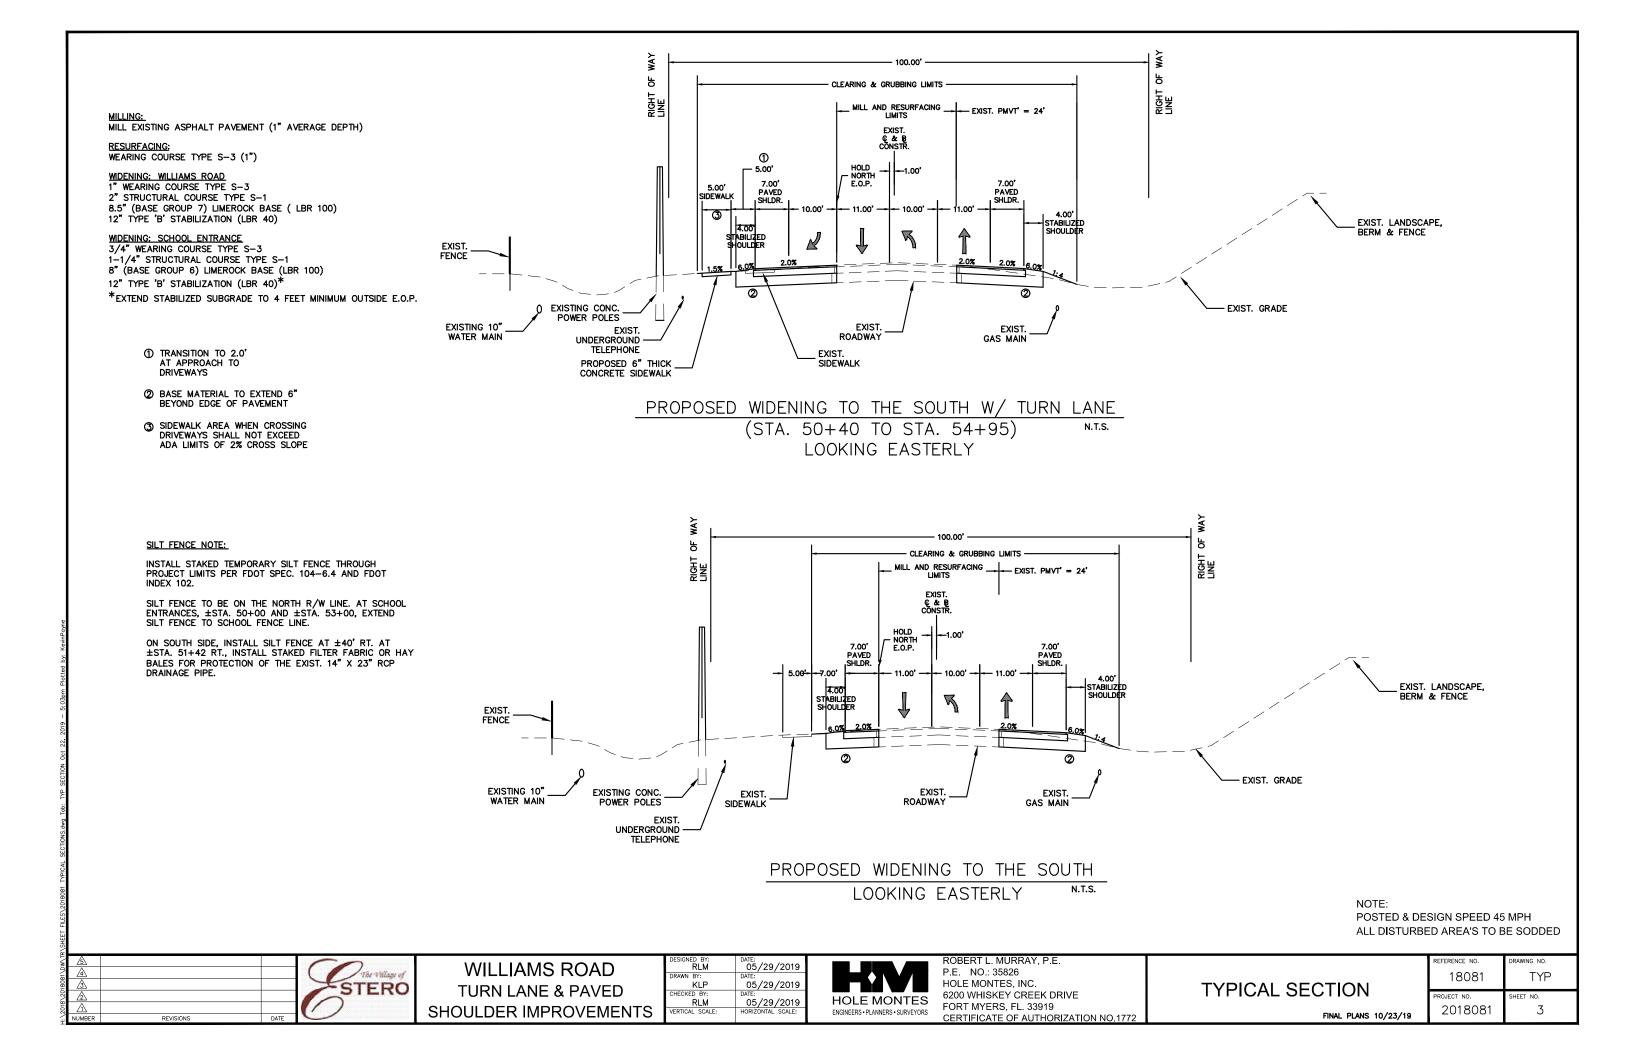

GENERAL NOTES:

- 1. BENCHMARK ELEVATIONS SHOWN ON THE PLANS ARE NORTH AMERICAN VERTICAL DATUM OF 1988 (NAVD 88).
- 2. THE CONTRACTOR SHALL NOTIFY ALL UTILITY COMPANIES A MINIMUM OF TWO (2) WORKING DAYS PRIOR TO EXCAVATION AS REQUIRED BY CHAPTER 77-153 OF THE FLORIDA STATUTES.
- CONTRACTOR SHALL FIELD VERIFY THE EXISTING PAVEMENT ELEVATIONS OF ALL З. DRIVEWAYS AND SIDEWALKS TO ENSURE THE PROPOSED IMPROVEMENTS MATCH EXISTING ELEMENTS AT CONNECTION.
- 4. THE INFORMATION SHOWN ON THESE DRAWINGS CONCERNING TYPE AND LOCATION OF UNDERGROUND AND OTHER UTILITIES IS BASED ON RECORDS AND SURVEYS AVAILABLE DURING PLAN DEVELOPMENT, BUT IS NOT GUARANTEED TO BE ACCURATE OR ALL INCLUSIVE. THE CONTRACTOR SHALL MAKE HIS OWN DETERMINATION AS TO THE TYPE AND LOCATION OF UTILITIES, AS MAY BE NECESSARY TO AVOID DAMAGE THERETO. THE CONTRACTOR IS RESPONSIBLE FOR ALL UTILITY LOCATES PRIOR TO AND DURING ANY CONSTRUCTION ACTIVITIES, AS WELL AS ANY COORDINATION OF UTILITY RELOCATION NECESSARY WITHIN THE PROJECT CONSTRUCTION. CONTRACTOR SHALL VERIFY DEPTH OF ALL EXISTING UTILITY MAINS AND ENSURE THAT THE MINIMUM COVERAGE TO THE TOP OF PIPE WILL BE MAINTAINED.

5. EXISTING UTILITIES ARE TO REMAIN IN PLACE UNLESS OTHERWISE NOTED.

6. UTILITY / AGENCY OWNERS:


COMPANY	<u>CONTACT</u>	PHONE No.
FP&L	Michael Martinez	239-353-6047
FIBERNET DIRECT	Danny Haskett	786-246-7827
COMCAST	Mark Cook	239-432-1805
TECO PEOPLES GAS	Marilyn Aloi	239-690-5517
CENTURY LINK	James Nottingham	239-336-2035
LEE COUNTY UTILITIES	William Boone	239-693-2992
CROWN CASTLE	Rebecca Caldwell	724-416-9917

- SOD ALL DISTURBED AREAS UNLESS OTHERWISE DIRECTED. SOD SHALL MATCH EXISTING TYPE SOD UNLESS OTHERWISE DIRECTED BY THE ENGINEER. SEED AND MULCH IS NOT ACCEPTABLE IN RIGHT-OF-WAY. SHOULDER SODDING SHALL BE PLACED 1" BELOW EDGE OF PAVEMENT IN ACCORDANCE WITH FDOT INDEX # 105.
- UNLESS OTHERWISE SPECIFIED, THE CONTRACTOR SHALL ADJUST ALL EXISTING 8. AND PROPOSED APPURTENANCES (I.E. VALVE BOXES, METER BOXES, PULL BOXES, MANHOLES, ETC.) MEANT TO BE FLUSH WITH FINISHED GRADE.
- 9. ALL PRIVATE AND PUBLIC PROPERTY AFFECTED BY THIS WORK SHALL BE RESTORED TO A CONDITION EQUAL TO OR BETTER THAN EXISTING CONDITIONS. COST TO BE INCIDENTAL TO OTHER CONSTRUCTION AND NO EXTRA COMPENSATION WILL BE ALLOWED.
- 10. UNLESS OTHERWISE NOTED. ALL REMOVED MATERIAL (EXCEPT FOR SIGNS) SHALL BECOME THE PROPERTY OF THE CONTRACTOR AND ARE TO BE APPROPRIATELY DISPOSED OF IN AREAS PROVIDED BY THE CONTRACTOR
- 11. ALL EXISTING DRAINAGE STRUCTURES AND PIPES WITHIN THE RIGHT-OF-WAY SHALL REMAIN, UNLESS OTHERWISE DIRECTED.
- 12. ALL P.R.M.'S SHOWN ON PLANS, OR FOUND, SHALL BE PRESERVED IN A PERMINENT MANNER

- 13. ANY U.S.C. & G.S. MONUMENTS (I.E. PUBLIC LAND CORNERS) WITHIN THE LIMITS OF CONSTRUCTION SHALL BE PROTECTED, AND IF IN DANGER OF DAMAGE, THE CONTRACTOR SHALL NOTIFY THE PROJECT ENGINEER AND THE STATE GEODETIC ADVISOR, 3900 COMMONWEALTH BOULEVARD, TALLAHASSEE, FL, (850)245-2606. CONTRACTOR SHALL BE RESPONSIBLE FOR ANY DAMAGE TO MARKERS AND SHALL REPLACE AT CONTRACTOR'S EXPENSE IF DAMAGED.
- 14. CONTRACTOR SHALL COOPERATE WITH THE OWNERS DESIGNATED REPRESENTATIVE(S) AT ALL TIMES WITH RESPECT TO SAMPLING, TESTING, AND INSPECTIONS.
- 15. SIGN LOCATIONS ARE APPROXIMATE AND SHALL BE FIELD VERIFIED AND NOTED BY THE CONTRACTOR PRIOR TO THE BEGINNING OF CONSTRUCTION.
- 16. ALL STATION/OFFSETS SHOWN ARE TO THE BASELINE OF CONSTRUCTION UNLESS OTHERWISE SPECIFIED. NO OTHER PROJECT CONTROL INFORMATION OTHER THAN THAT SHOWN IN THESE PLANS WILL BE PROVIDED. PRIOR TO FIRST APPLICATION FOR PAYMENT. THE CONTRACTOR SHALL STAKE THE RIGHT OF WAY AT 100 FEET WHOLE-STATION INTERVALS (WITH STATIONING SHOWN ON THE STAKES).
- 17. WITH EXCEPTION OF MAILBOXES, ALL PERSONAL PROPERTY WITHIN THE RIGHT-OF-WAY THAT IS NOT RELOCATED BY THE PROPERTY OWNER SHALL BE REMOVED BY THE CONTRACTOR AS NECESSARY TO CONSTRUCT THE PROJECT IN ACCORDANCE WITH THE PLANS.
- 18. CONTRACTOR IS TO MAINTAIN UNINTERRUPTED ACCESS TO ALL DRIVEWAYS AT ALL TIMES AND IS TO NOTIFY PROPERTY OWNERS FIVE (5) DAYS PRIOR TO STARTING CONSTRUCTION ADJACENT TO THEIR INDIVIDUAL PROPERTIES.
- 19. ACCESS TO INTERSECTING SIDE STREETS SHALL BE MAINTAINED AT ALL TIMES.
- 20. CONTRACTOR SHALL PERFORM WORK IN ACCORDANCE WITH REQUIREMENTS OF FDOT STANDARD SPECIFICATIONS, SECTION 104 - PREVENTION, CONTROL, AND ABATEMENT OF EROSION AND WATER POLLUTION. ENVIRONMENTAL CONTROLS SHALL BE USED AT LOCATIONS DESIGNATED IN THE STORMWATER POLLUTION PREVENTION PLAN (SWPPP) PROVIDED IN THESE PLANS AND/OR APPROVED BY THE ENGINEER.
- 21. IN LOCATIONS WHERE EXISTING ASPHALT IS TO BE SAWCUT OR CURBING IS TO BE REMOVED / REPLACED WITH NEW CURB OR CURB & GUTTER, CONTRACTOR SHALL BE RESPONSIBLE FOR PROTECTION OF THE EXISTING TRAVEL LANES THROUGH THE DURATION OF THE PROJECT, AND SHALL BE REQUIRED TO REPAIR ANY PAVEMENT THAT IS DAMAGED DURING CONSTRUCTION TO THE SATISFACTION OF THE OWNER, WHICH COULD ENTAIL MILLING/RESURFACING AND/OR FULL DEPTH RECONSTRUCTION OF THE PAVEMENT SECTION DEPENDING UPON THE LEVEL OF DAMAGE THAT MAY OCCUR.
- 22. CONTRACTOR SHALL NOT CREATE A PUBLIC NUISANCE INCLUDING, BUT NOT LIMITED TO, ENCROACHMENT ON ADJACENT LANDS, FLOODING OF ADJACENT LANDS, OR EXCESSIVE NOISE. SOUND LEVELS SHALL NOT EXCEED 65 DBA 7 A.M. TO 10 P.M., OR 60 DBA FROM 10 P.M. TO 7 A.M. WHEN PERMITTED TO WORK AT NIGHT. THIS SOUND LEVEL SHALL BE MEASURED AT THE EXTERIOR OF THE NEAREST EXTERIOR WALL OF THE NEAREST RESIDENCE. LEVELS AT THE EQUIPMENT SHALL NOT EXCEED 85 DBA AT ANY TIME. SOUND LEVELS IN EXCESS OF THESE VALUES ARE SUFFICIENT CAUSE TO HAVE THE WORK HALTED UNTIL EQUIPMENT CAN BE QUIETED TO THESE LEVELS. WORK STOPPAGE BY THE ENGINEER OR OWNER FOR EXCESSIVE NOISE SHALL NOT RELIEVE THE CONTRACTOR OF THE COMPLETION DATES AND BID AMOUNTS, AND NO ADDITIONAL COMPENSATION OR SCHEDULE EXTENSIONS WILL BE PROVIDED FOR TIME LOST DUE TO WORK STOPPAGE RESULTING FROM THE CREATION OF A PUBLIC NUISANCE.

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WILLIAMS ROAD **TURN LANE & PAVED** SHOULDER IMPROVEMENTS



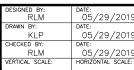


ROBERT L. MURRAY, P.E. P.E. NO.: 35826 HOLE MONTES, INC. 6200 WHISKEY CREEK DRIVE FORT MYERS, FL. 33919 CERTIFICATE OF AUTHORIZATION NO.1772


EXISTING UTILITIES.

24. REFER TO SHEET 23 FOR SIGNING AND MARKING GENERAL NOTES.

23. WHEN NOTED FOR REMOVAL IN THESE PLANS, EXISTING TREES SHALL BE COMPLETELY REMOVED BY THE CONTRACTOR, INCLUDING LIMBS, TRUNKS, AND THEIR ROOT SYSTEM(S). CONTRACTOR SHALL USE CAUTION WHEN REMOVING EXISTING TREES IN ORDER TO AVOID DAMAGE TO OTHER ELEMENTS THAT MAY BE IN CLOSE PROXIMITY, SUCH AS FENCES OR OTHER PRIVATE PROPERTY, EXISTING UTILITIES, OTHER TREES, ETC. CONTRACTOR SHALL BE SOLELY RESPONSIBLE FOR ANY DAMAGE CAUSED, AND NO ADDITIONAL COMPENSATION SHALL BE PROVIDED TO RESTORE ITEMS THAT ARE DAMAGED DURING CONSTRUCTION. IN LOCATIONS WHERE SUBSTANTIAL ROOT SYSTEMS ARE ENCOUNTERED IN CLOSE PROXIMITY TO EXISTING UTILITIES, CONTRACTOR SHALL CONTACT THE PUBLIC WORKS DIRECTOR TO DETERMINE WHETHER OR NOT PORTIONS OF EXISTING ROOT SYSTEMS WILL BE PERMITTED TO REMAIN IN THE GROUND IN ORDER TO AVOID DISRUPTION OF

	REFERENCE NO.	DRAWING NO.
GENERAL NOTES	18081	GN-1
GENERAL NOTES	PROJECT NO.	SHEET NO.
FINAL PLANS 10/23/19	2018081	5

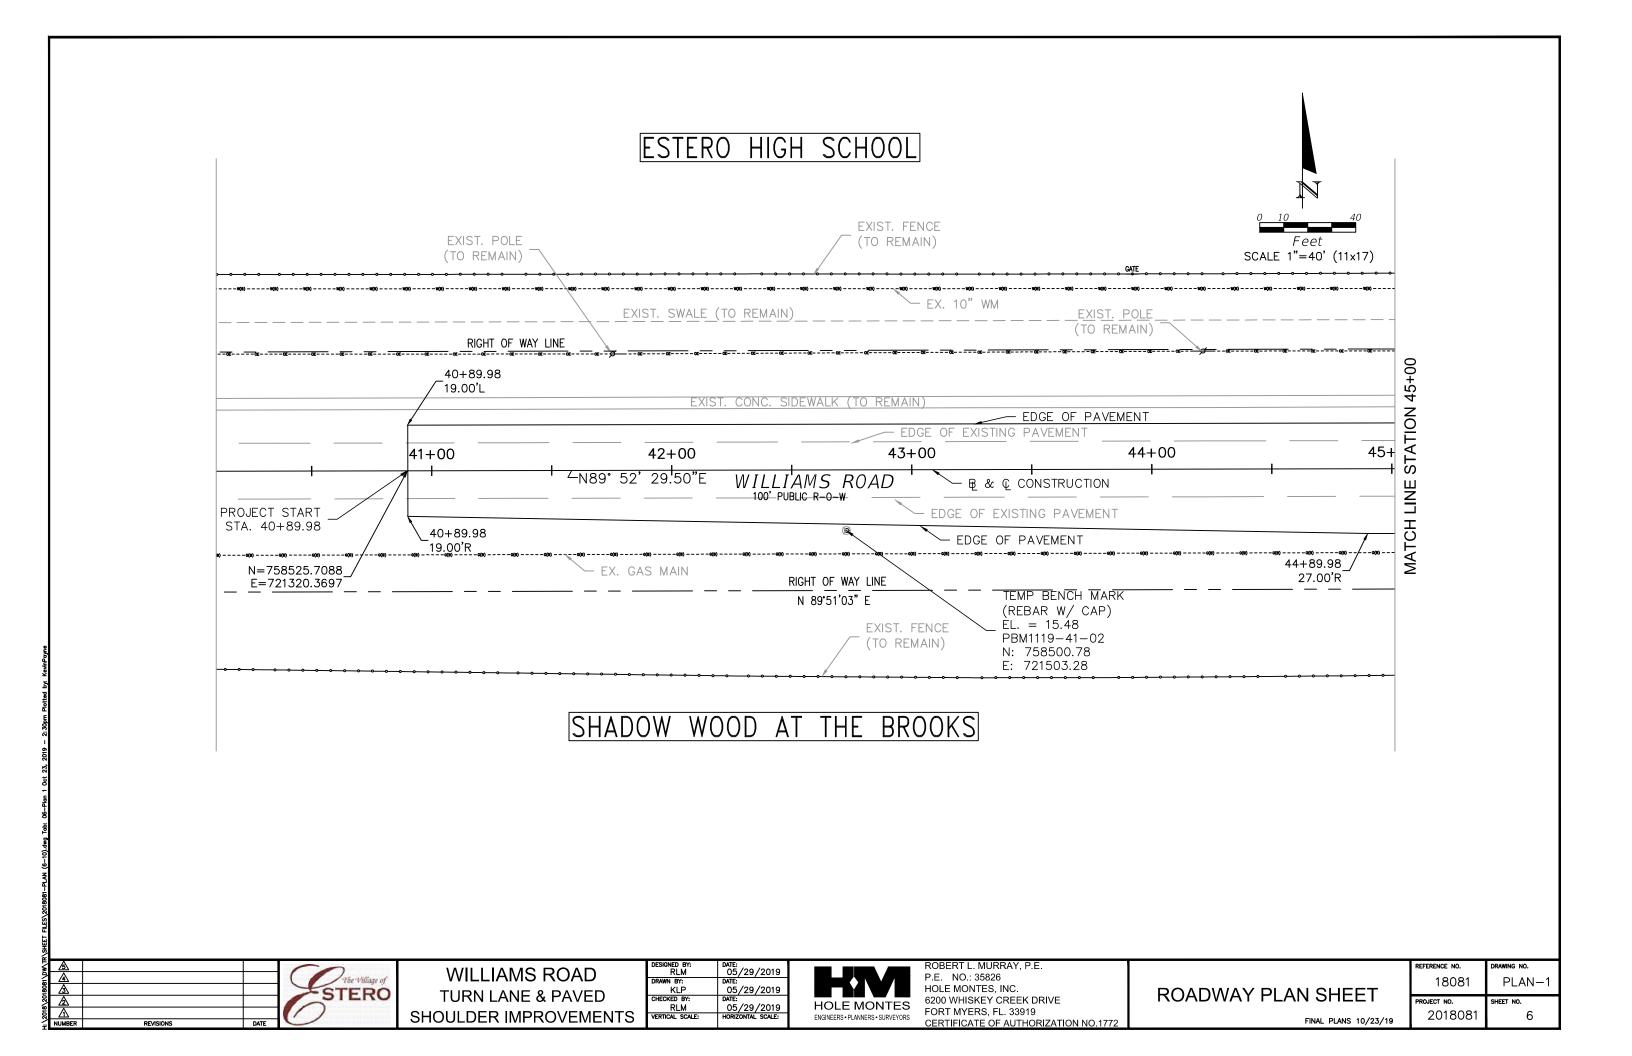

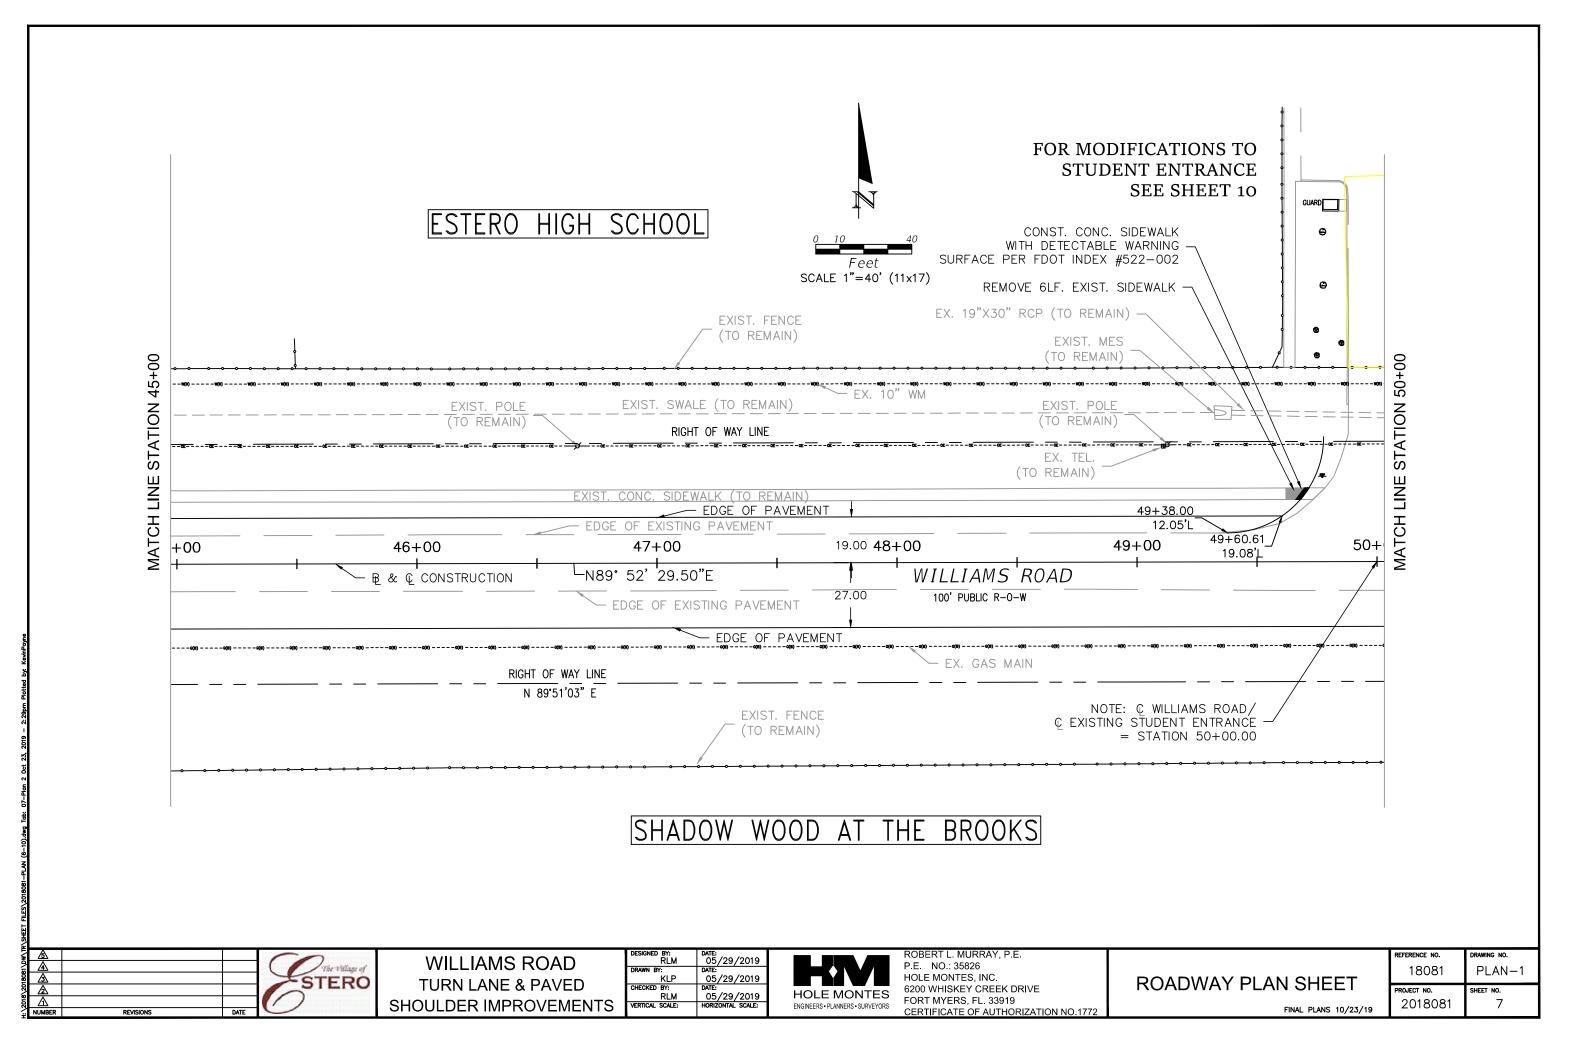

FOR MODIFICATIONS TO STUDENT ENTRANCE ESTERO HIGH SCHOOL **SEE SHEET 10** CONST. DETECTABLE WARNING SURFACE PER FDOT INDEX #522-002 EX. TEL. PULL BOX ADJ. TO GRADE (BY OTHERS) LIMITS OF EXIST. POLE CONSTRUCTION 10' FPL ESMT' (TO REMAIN) MATCH EXIST. CURVE TO MEE CONST. DETECTABLE WARNING OR BK 3200 PG 1561 PAVEMENT - EXISTING SURFACE PER FDOT INDEX #522-002 S-1PAVEMENT EXIST. DRAINAGE STATION 50+00 79.53'L-EXIST. MES. -79.46**'**L STRUCTURE • (TO REMAIN) (TO REMAIN) GATE EX. 10" WM EXIST. SWALE 'X30" RCP (TO REMAIN) ΕX 19"X30" RCP (TO REMAIN) RIGHT OF WAY LINE R60\C MATCH LINE 52+40.00 50+68.00 31.00**'**L R60.00 52+25.00 52+55.44 R40.00 53+44.36 . 31.00'L 50+53.00 34.00'L 53+59.56 53+71.00 51+61.00 31.00'L 29.00'L . 34.00'L 29.00'L 52+37.73 52+11.00 53+56.00 19.00'L 19.00'L 54+00 52+00 53+00 51+00 +00 31.00'L ∠N89° 52' 29.50"E WILLIAMS ROAD EDGE OF EXISTING PAVEMENT <u>5</u>0+5<u>1.99</u> 100' PUBLIC R-O-W 29.00'L EXIST. MES. EDGE OF EXISTING PAVEMENT (TO REMAIN) EDGE OF PAVEMEN EXIST. 14"X23" RCP (TO REMAIN) - EX. GAS MAIN (TO REMAIN) RIGHT OF WAY LINE N 89'51'03" E EXIST. STRUCTURE S-1 DRAINAGE INLET TOP ELEV = 14.00 W INV 19"x30" RCP ELEV = 12.01 EXIST. FENCE S INV 14"x23" RCP ELEV = 11.89 (TO REMAIN) E INV 19"x30" RCP ELEV = 12.00 BOTTOM ELEV = 11.95 SHADOW WOOD AT THE BROOKS ROBERT L. MURRAY, P.E. ED BY: RLM 05/29/2019 WILLIAMS ROAD P.E. NO.: 35826 DATE: 05/29/2019 DATE: The Village of KLP CHECKED BY: HOLE MONTES, INC. STERO **TURN LANE & PAVED** 6200 WHISKEY CREEK DRIVE 05/29/2019 HORIZONTAL SCALE: HOLE MONTES VERTICAL SCALE:


SHOULDER IMPROVEMENTS


REVISION

FORT MYERS, FL. 33919


CERTIFICATE OF AUTHORIZATION NO.1772


ENGINEERS • PLANNERS • SURVEYORS

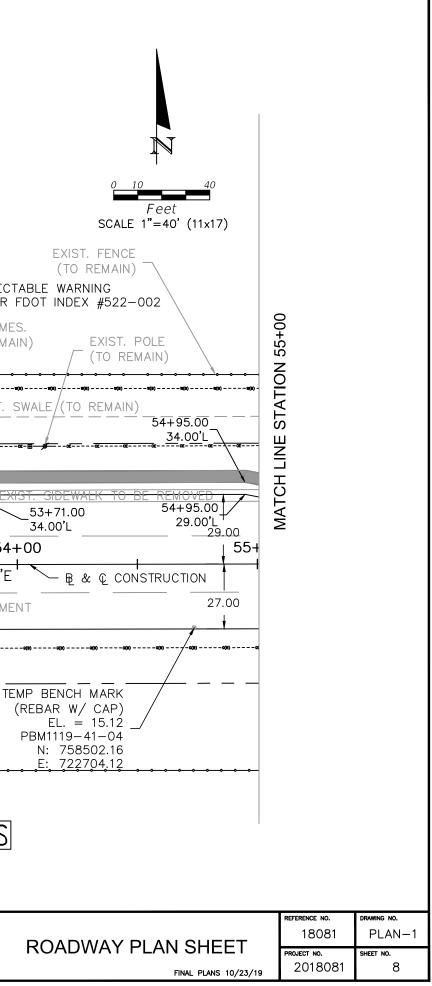


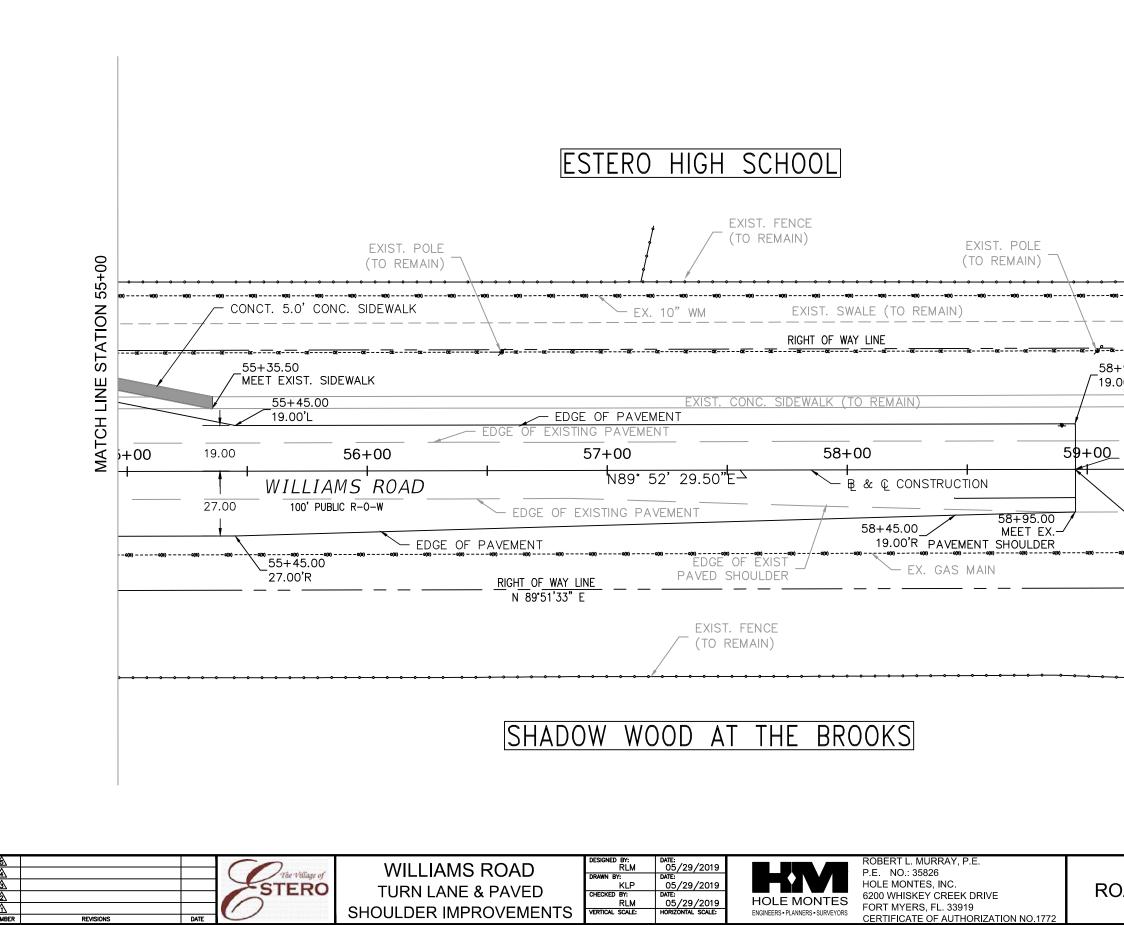



0 10 40 Feet SCALE 1"=40' (11x17)		
+95.00 00'L		
END OF PROJECT ST <u>A. 58+95.00</u> (END NEW PAVEMENT 60+ AT EXISTING 1 TRANSVERSE PAVEMENT JOINT)		
N=758529.6511 E=723125.3854 		
DADWAY PLAN SHEET FINAL PLANS 10/23/19	reference no. 18081 project no. 2018081	drawing no. PLAN—1 sheet no. 9

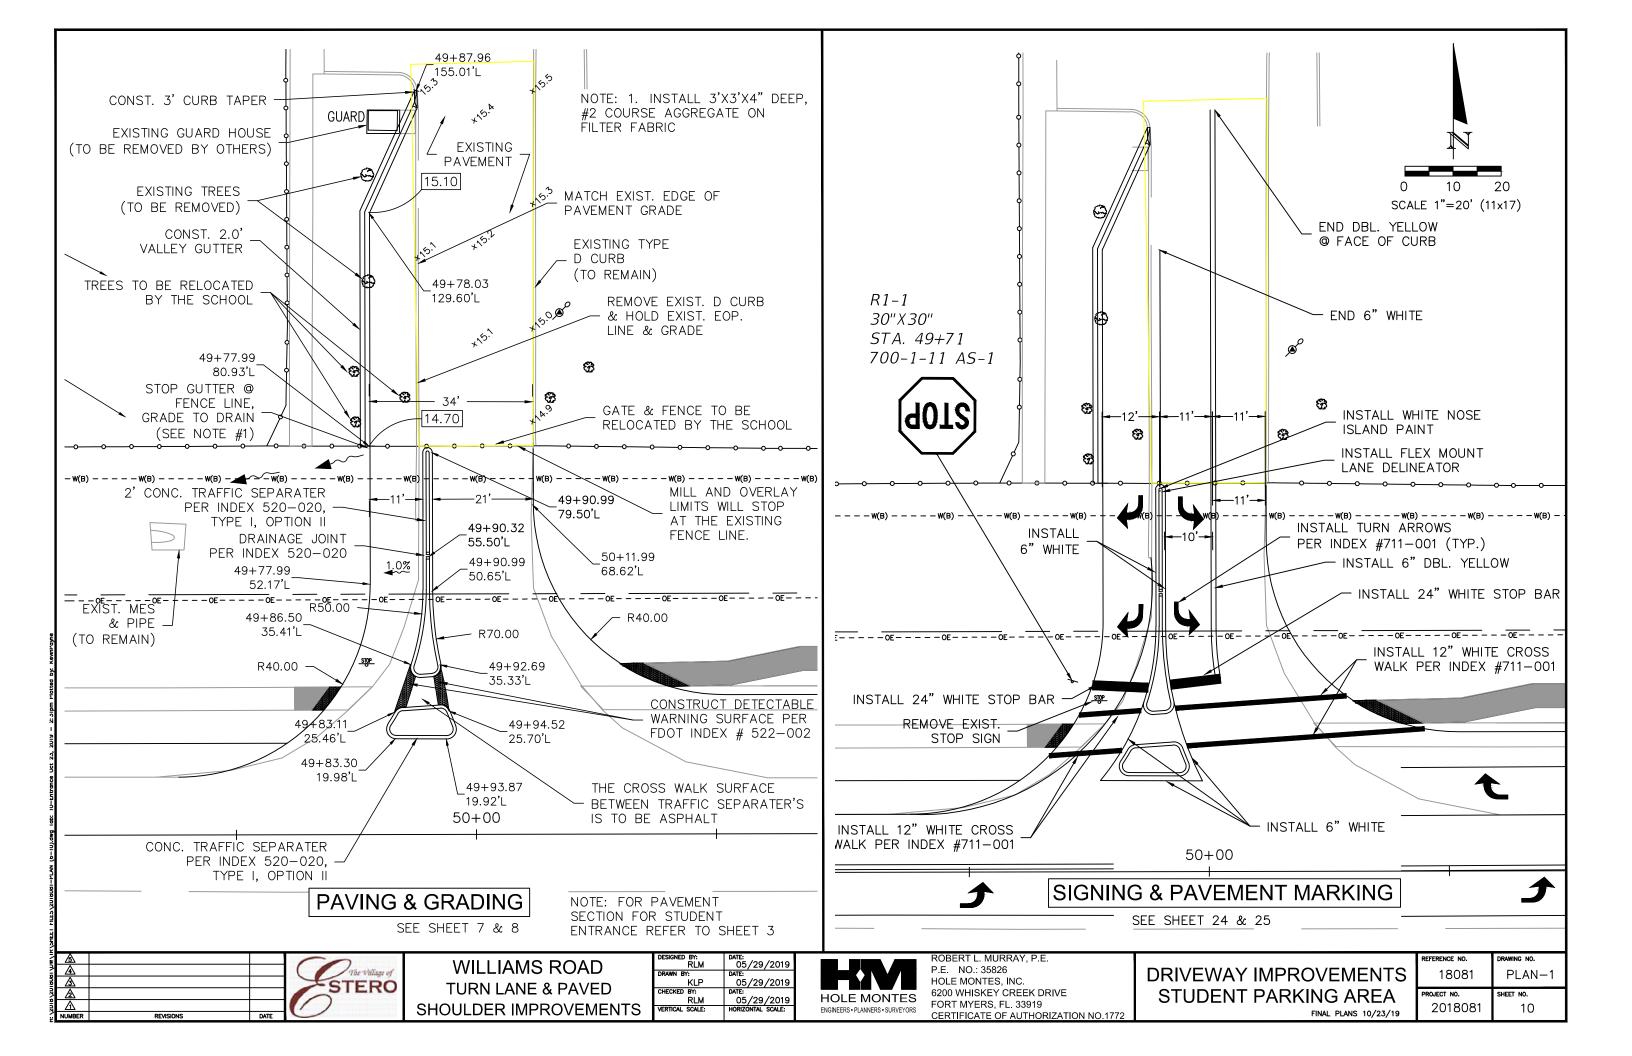


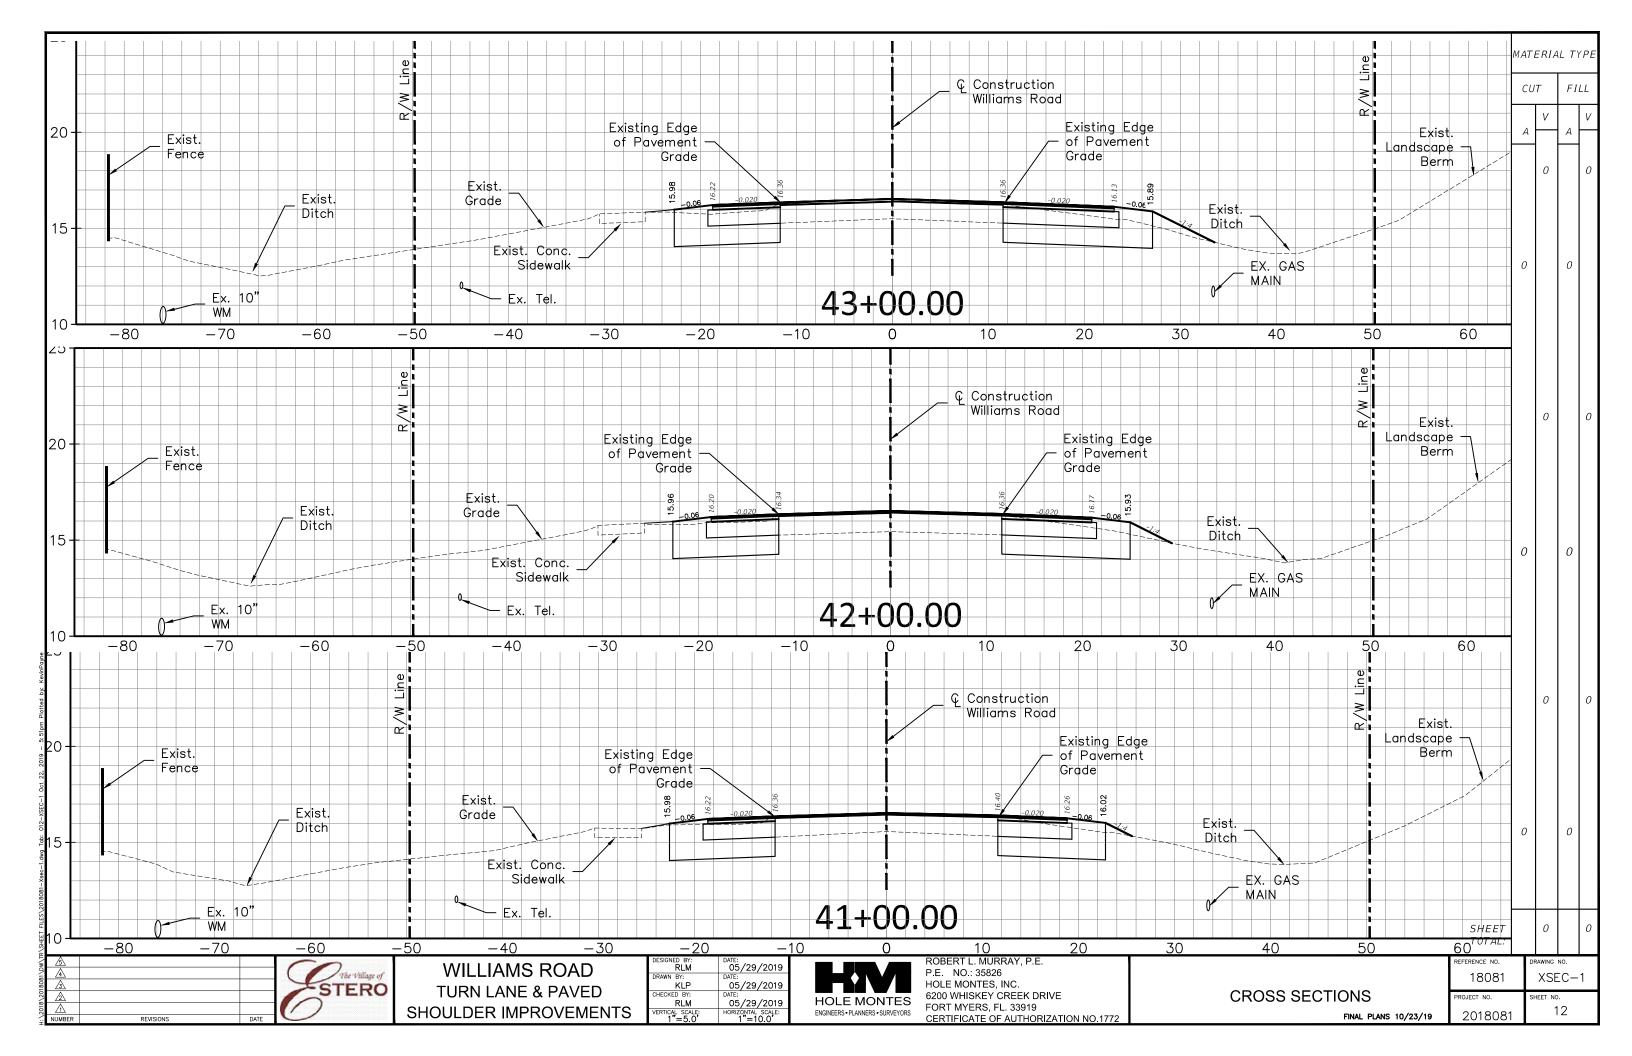


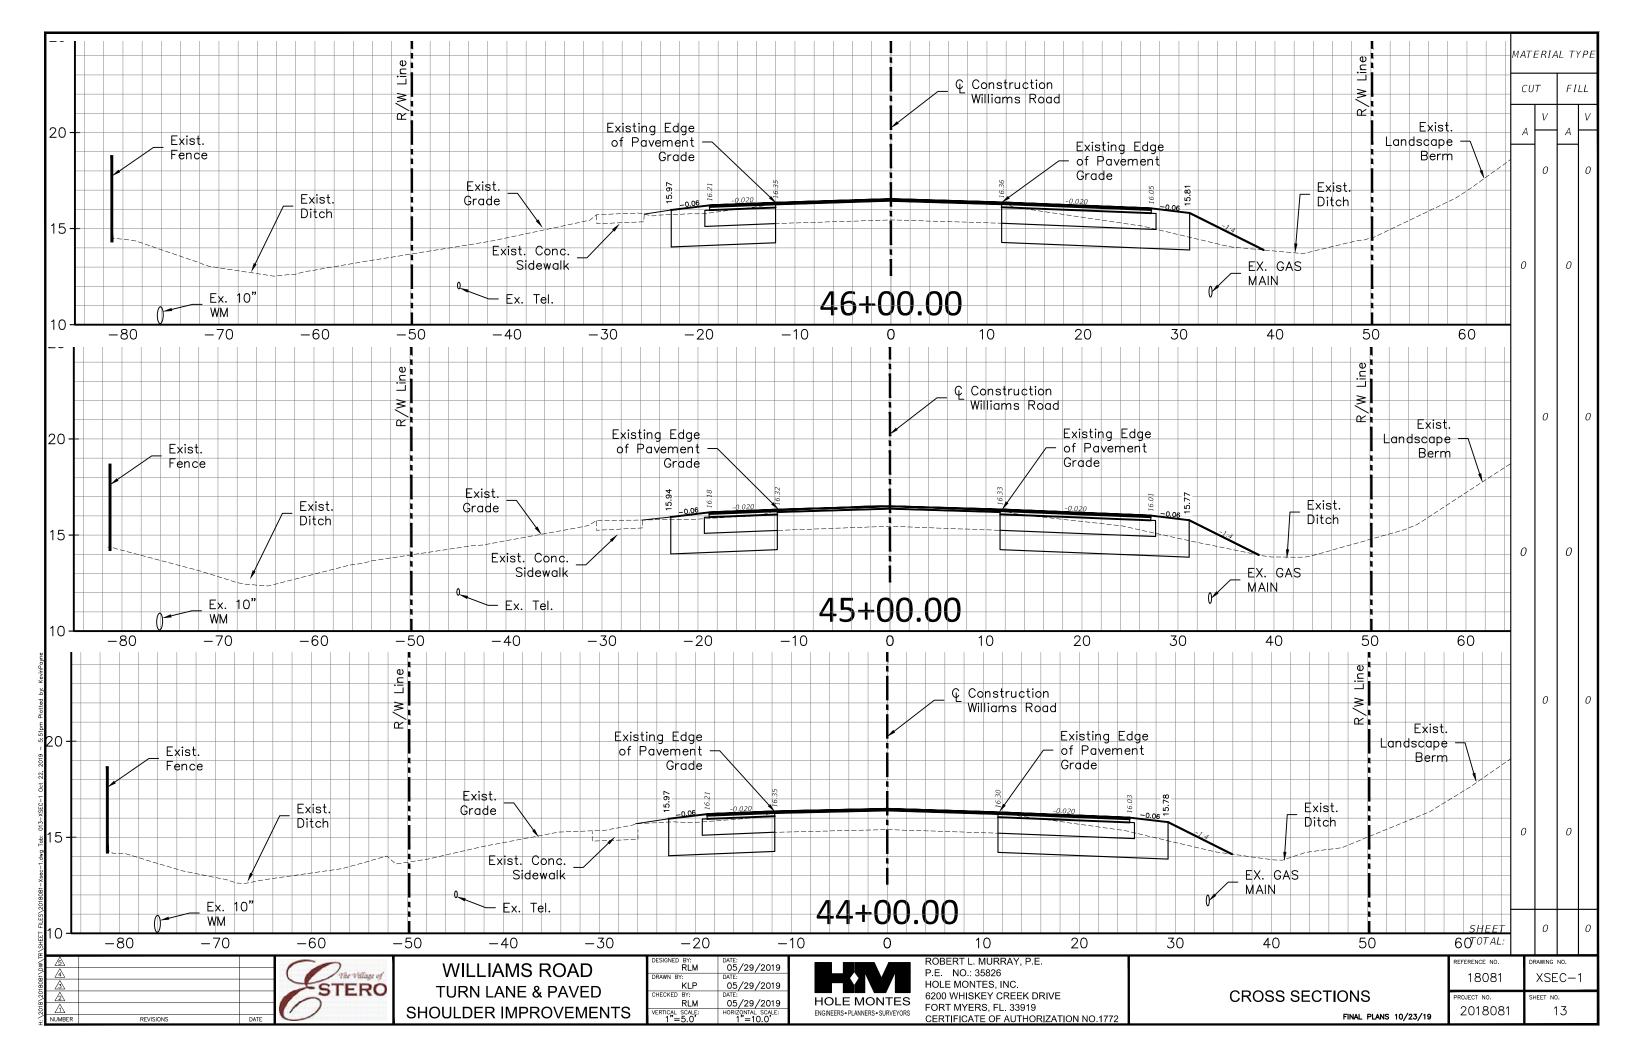


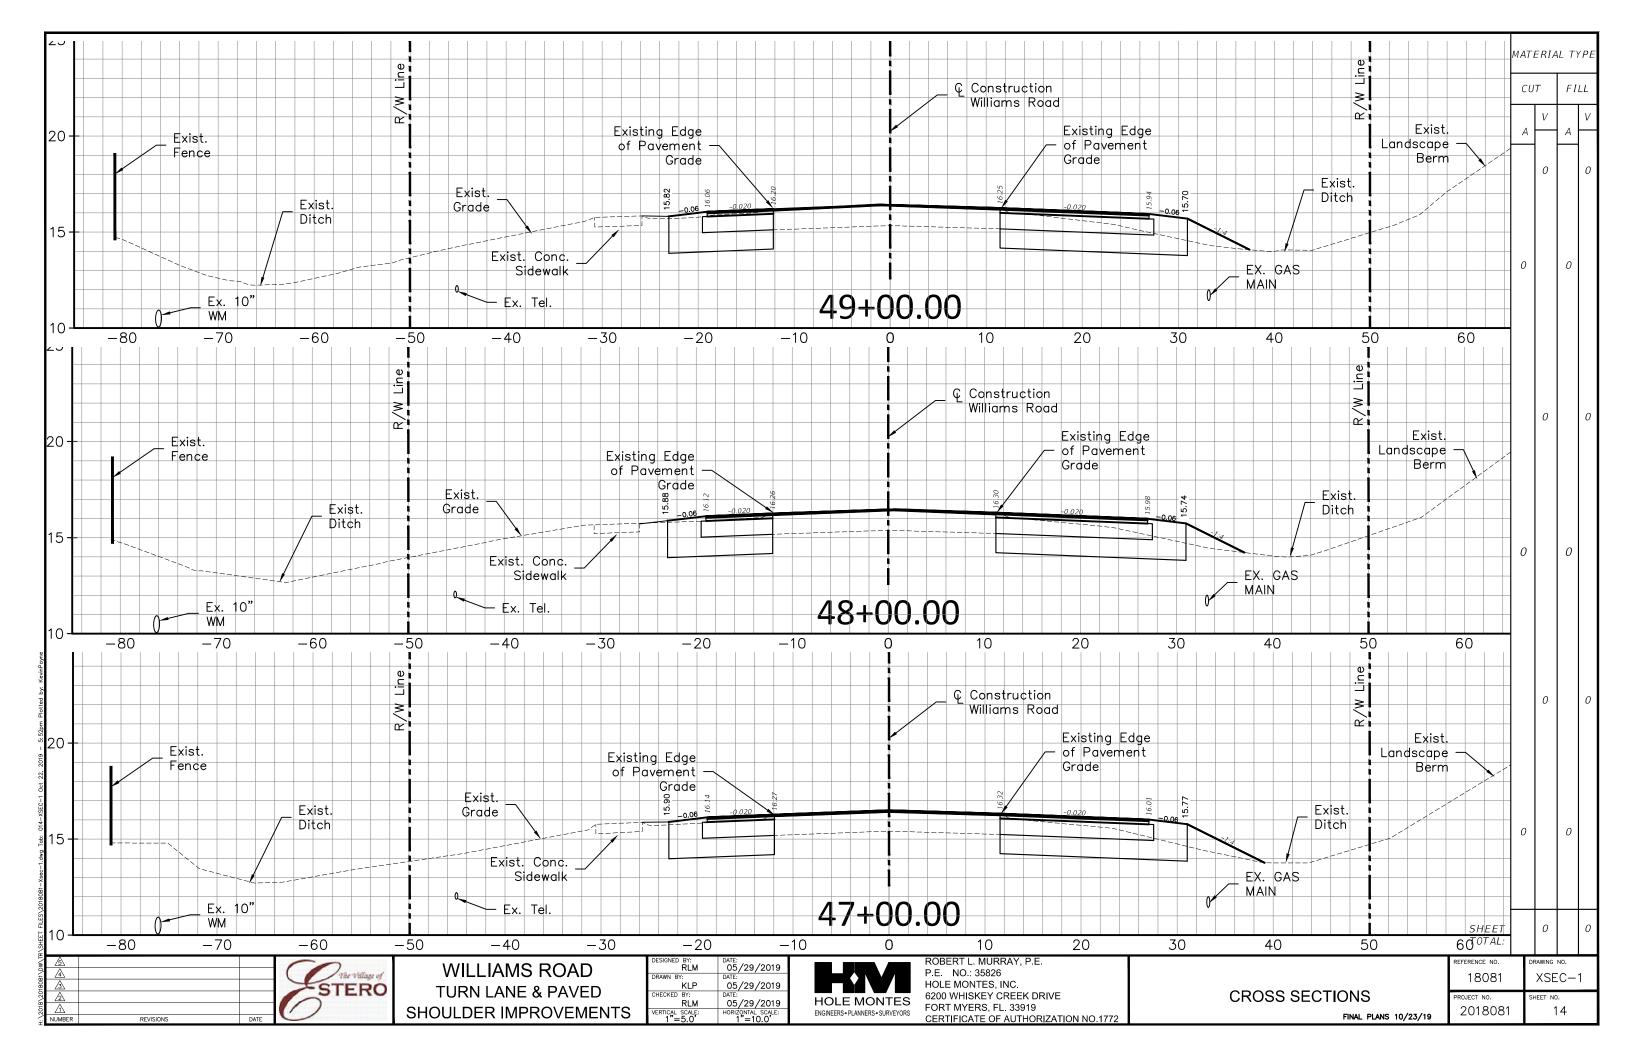

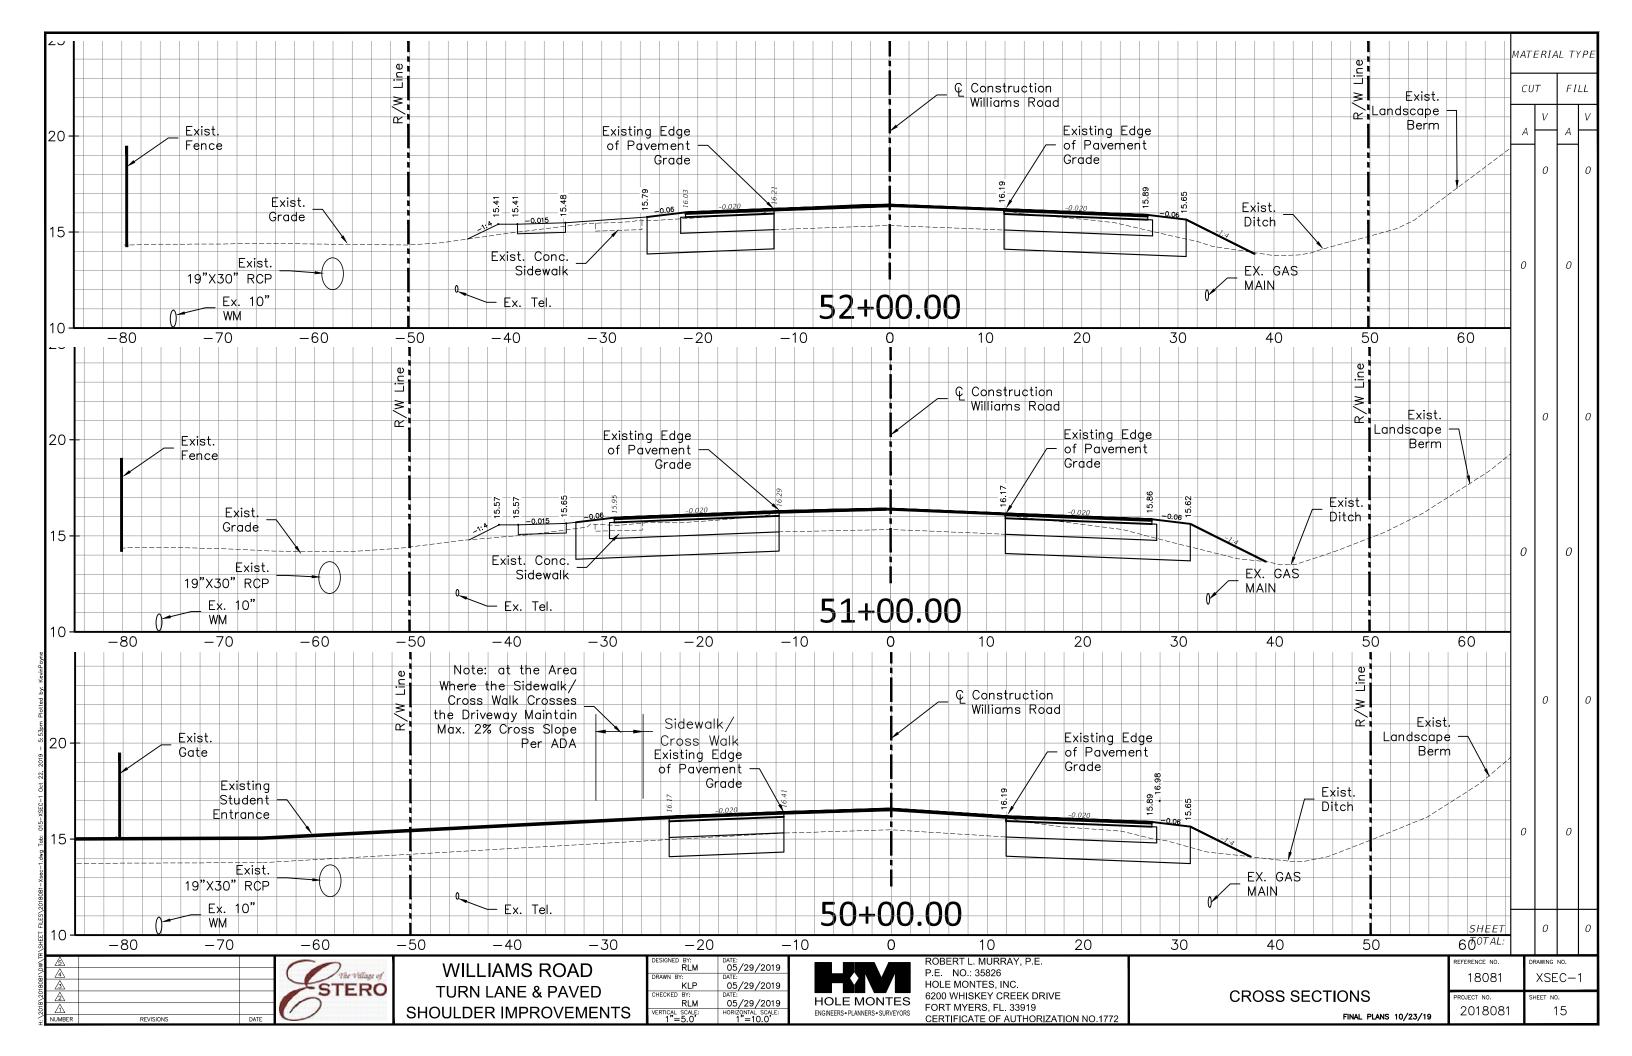

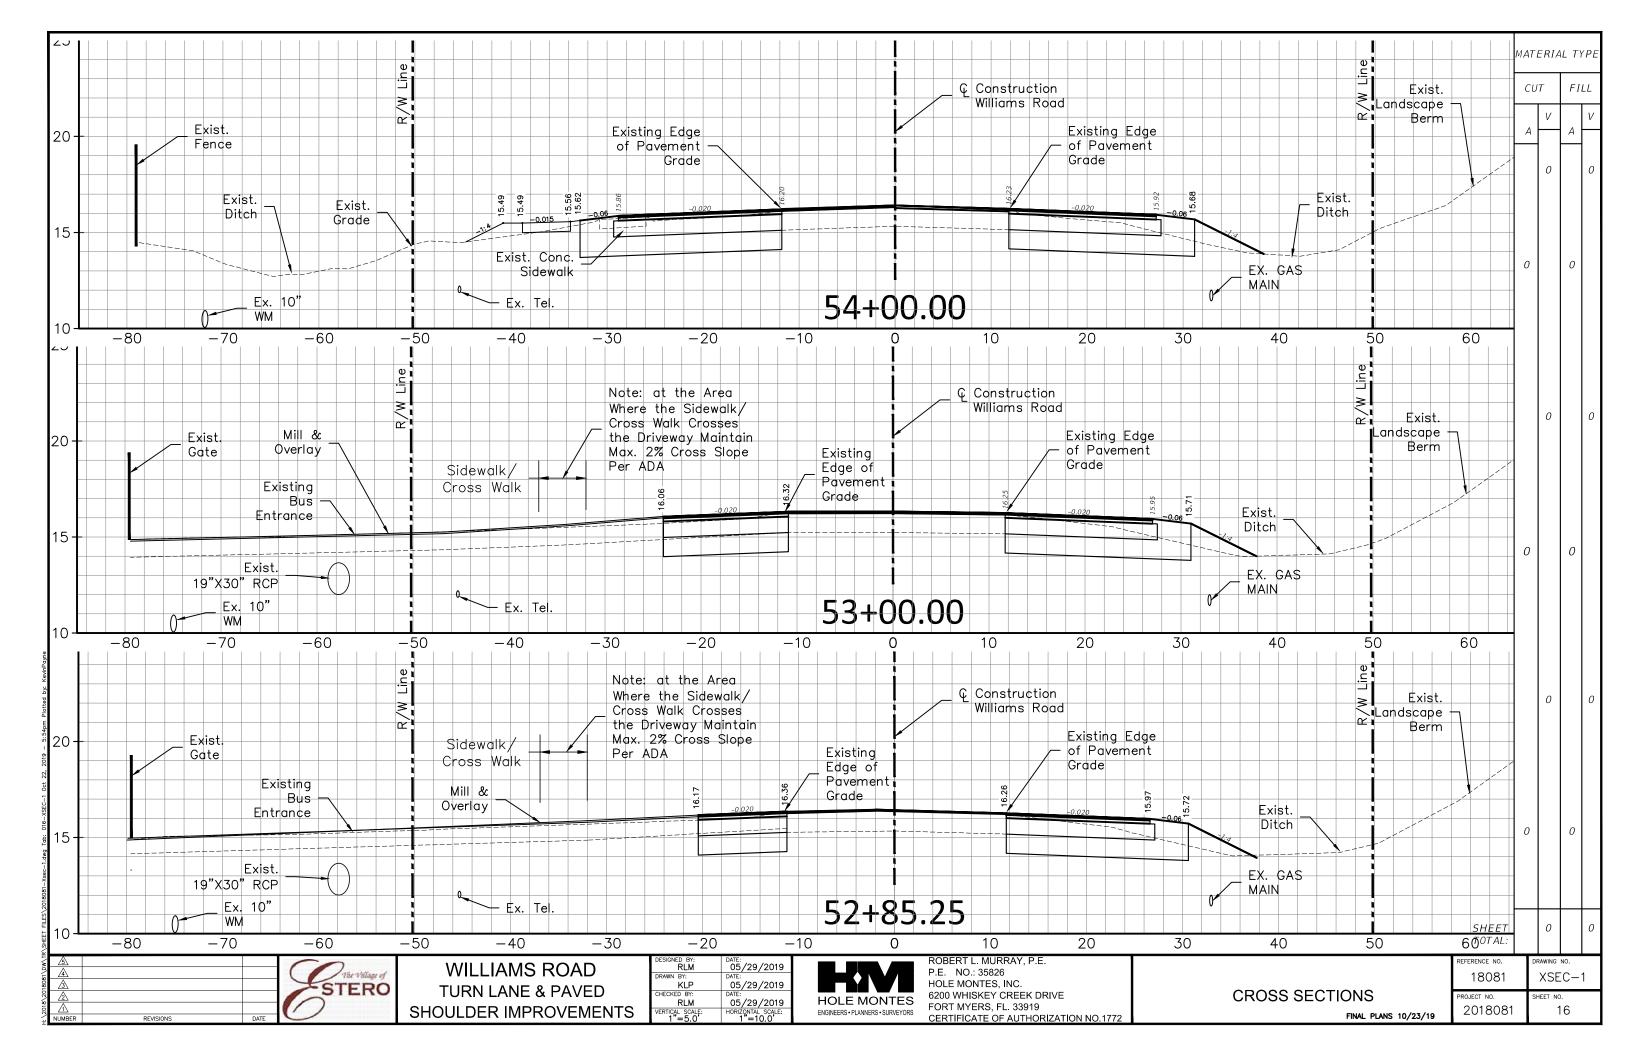

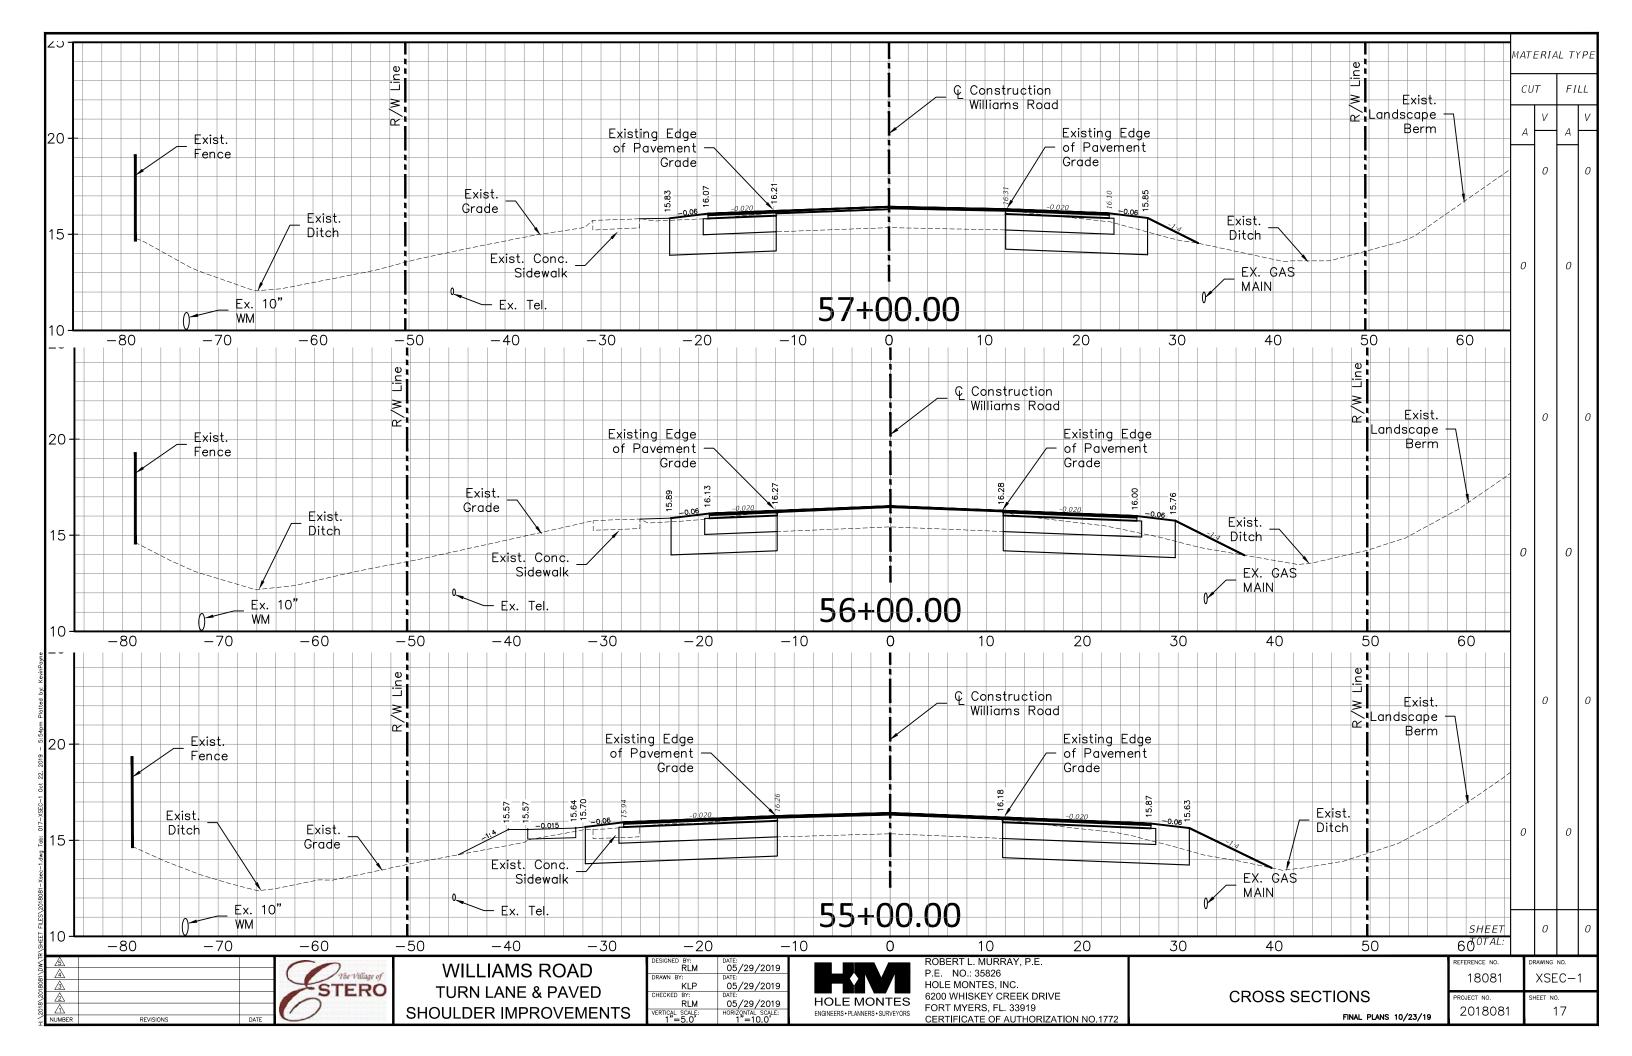

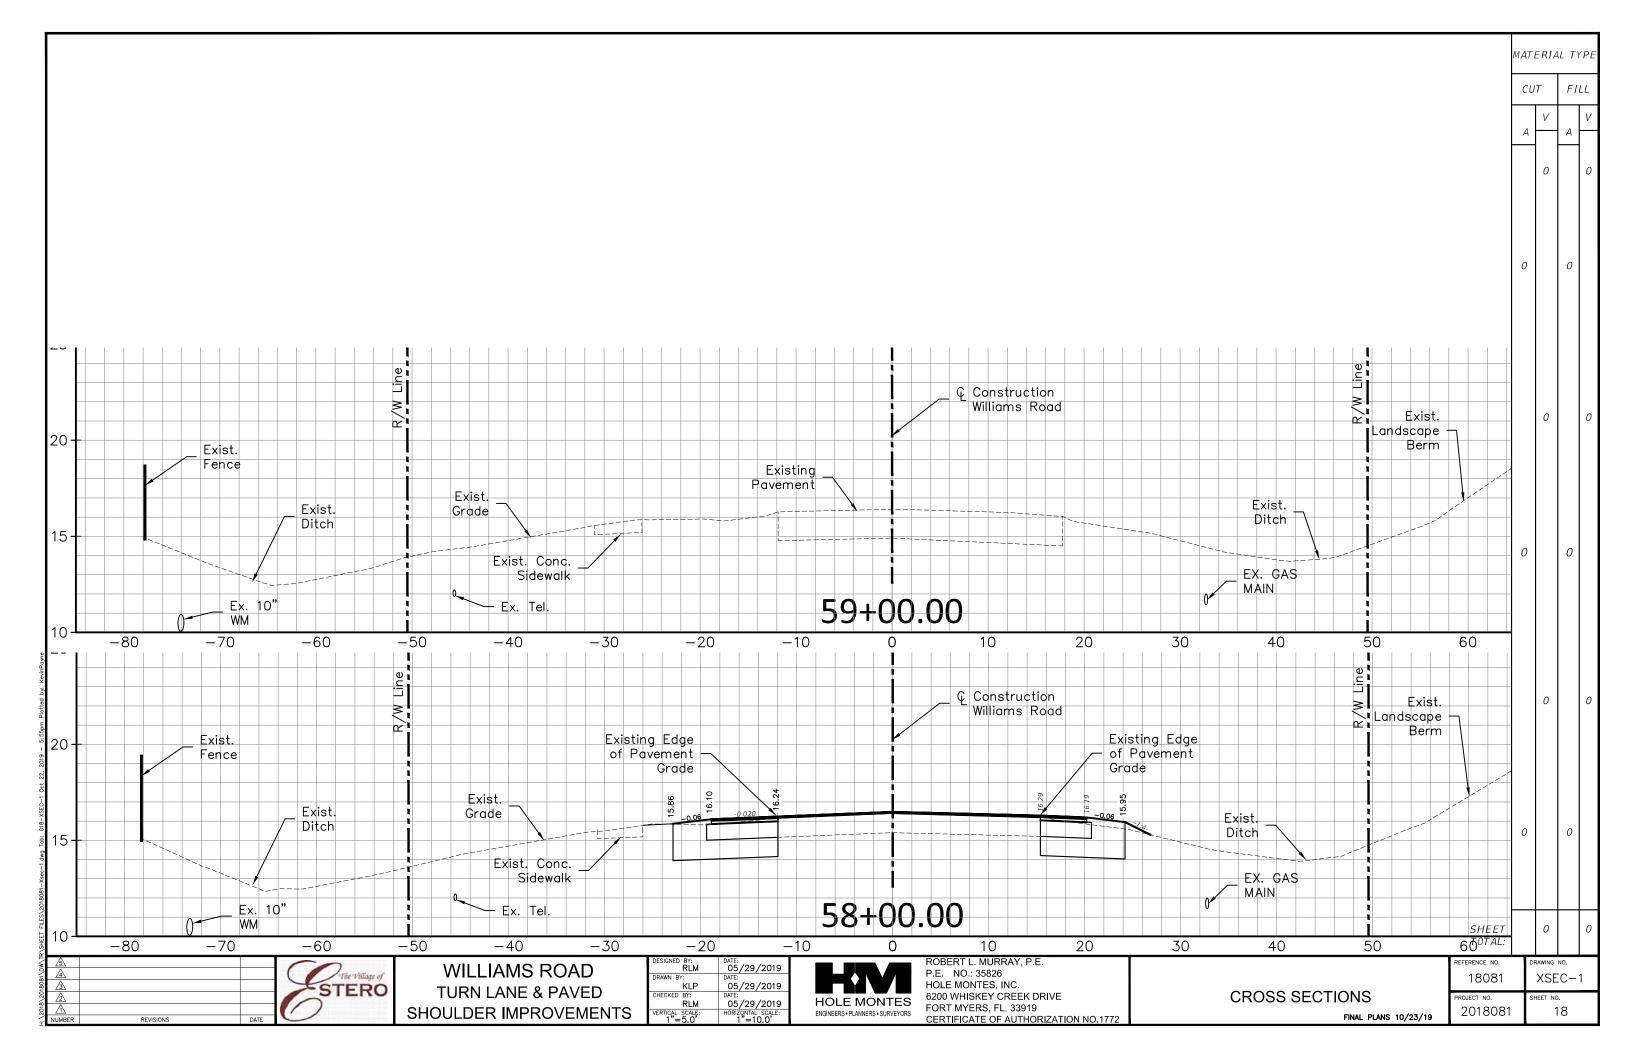

SITE DESCRIPTION

1.A. NATURE OF CONSTRUCTION ACTIVITY:

THIS IS A ROADWAY CONSTRUCTION PROJECT INCLUDING WIDENING THE EXISTING PAVEMENT FOR 11 FOOT WIDE THROUGH LANES, 10 FOOT WIDE TURN LANES AND 7 FOOT WIDE BUFFERED BIKE LANES, AND A SHORT SEGMENT OF EXISTING SIDEWALK WILL BE RELOCATED ALONG WILLIAMS ROAD. RECONSTRUCTED DRIVEWAYS FOR THE STUDENT PARAKING AND BUS PARKING ENTRANCES AT THE ESTERO HIGH SCHOOL ARE PROPOSED.

1.B. SEQUENCE OF MAJOR SOIL DISTURBING ACTIVITIES:

IN THE SECTION 104 EROSION CONTROL PLAN, THE CONTRACTOR SHALL PROVIDE A DETAILED SEQUENCE OF CONSTRUCTION FOR ALL CONSTRUCTION ACTIVITIES. THE CONTRACTOR SHALL FOLLOW THE SEQUENCE OF MAJOR ACTIVITIES DESCRIBED BELOW, UNLESS THE CONTRACTOR PROPOSES A DIFFERENT SEQUENCE THAT IS EQUAL OR BETTER AT CONTROLLING EROSION AND TRAPPING SEDIMENT AND IS APPROVED BY THE ENGINEER.

FOR EACH CONSTRUCTION PHASE, INSTALL PERIMETER CONTROLS AFTER CLEARING AND GRUBBING NECESSARY FOR INSTALLATION OF CONTROLS BUT BEFORE BEGINNING OTHER WORK FOR THE CONSTRUCTION PHASE. REMOVE PERIMETER CONTROLS ONLY AFTER ALL UPSTREAM AREAS ARE STABILIZED.

SEQUENCE OF ACTIVITIES:

INSTALL CONSTRUCTION SIGNS AND TRAFFIC CONTROL DEVICES PRIOR TO CONSTRUCTION.

PHASE 1 WILL ESTABLISH EROSION CONTROL.

PHASE 2 SHALL CONSIST OF CONSTRUCTING NEW PAVEMENT, SIDEWALK AND DRIVEWAYS.

PHASE 4 SHALL CONSIST OF RESTORATION, INCLUDING PERFORMANCE SOD PLACEMENT, REPLACEMENT OF SIGNAGE, FINAL SIGNING AND PAVEMENT MARKING INSTALLATION, AND FINAL SITE CLEANUP.

1.C. SITE MAP

DRAINAGE PATTERNS WITHIN THE PROJECT LIMITS CONSIST OF OPEN DRAINAGE ALONG BOTH SIDES OF WILLIAMS ROAD. STORMWATER RUNOFF AND DISCHARGE LOCATION FOR THE PROJECT WILL REMAIN UNALTERED. NO CHANGES ARE PROPOSED TO THESE ELEMENTS.

APPROXIMATE SLOPES ARE 4:1 FOR SIDE SLOPES, AND 1.5% CROSS SLOPE AT THE SIDEWALK, LONGITUDINAL SLOPE FOR THE EXISTING ROADWAY IS FAIRLY FLAT. NO CHANGES TO THESE SLOPES ARE PROPOSED. AREA OF SOIL DISTURBANCE IS SHOWN IN 1.C. ABOVE.

1.D. OUTFALL INFORMATION:

THE PROJECT DISCHARGES AT THE FOLLOWING LOCATION; DISCHARGE FOR THE NORTH SIDE OF WILLIAMS ROAD IN A CULVERT UNDER RIVER RANCH ROAD, EAST OF THE PROJECT.

2.0 CONTROLS

2.A. EROSION AND SEDIMENT CONTROLS

THE SOIL EROSION AND SEDIMENT CONTROL SHALL BE MAINTAINED BY THE CONTRACTOR TO MINIMIZE THE AMOUNT OF DISTURBED SOIL, PREVENT OFFSITE RUNOFF FROM FLOWING ACROSS DISTURBED AREAS, SLOW THE RUNOFF FLOWING ACROSS THE SITE AND REMOVE SEDIMENT FROM ONSITE RUNOFF BEFORE IT LEAVES THE SITE.

THE CONTRACTOR IS ADVISED THAT THE CONTRACT DRAWINGS ONLY INDICATE EROSION, SEDIMENT, AND TURBIDITY CONTROLS AT LOCATIONS DETERMINED IN THE DESIGN PROCESS. HOWEVER, THE CONTRACTOR IS REQUIRED TO PROVIDE ANY ADDITIONAL CONTROLS NECESSARY TO PREVENT THE POSSIBILITY OF SILTING ANY ADJACENT LOW LAND PARCEL OR RECEIVING WATER.

SOIL DISTURBING ACTIVITIES WILL BE ASSOCIATED WITH PAVEMENT, SIDEWALK AND DRAINAGE INSTALLATION, THE FOLLOWING CONSTRUCTION PHASING IS IDENTIFIED IN THE TRAFFIC CONTROL PLANS:

HASE 1

EROSION CONTROL. PHASE 2 CONSTRUCT PAVEMENT, SIDEWALK, AND DRIVEWAYS. CONCURRENT WITH PHASES 1 AND 2 RESTORE RIGHT OF WAY, RE-INSTALL SIGNS, PLACE SOD AND CLEANUP.

2.A.1. STABILIZATION PRACTICES:

IN THE SECTION 104 (FROM THE FDOT SPECS FOR ROAD AND BRIDGE CONSTRUCTION) EROSION CONTROL PLAN, THE CONTRACTOR SHALL DESCRIBE THE STABILIZATION PRACTICES PROPOSED TO CONTROL EROSION. THE CONTRACTOR SHALL INITIATE ALL STABILIZATION MEASURES AS SOON AS PRACTICAL, BUT IN NO CASE MORE THAN 7 DAYS, IN PORTIONS OF THE SITE WHERE CONSTRUCTION ACTIVITIES HAVE TEMPORARILY OR PERMANENTLY CEASED. THE STABILIZATION PRACTICES SHALL INCLUDE AT LEAST THE FOLLOWING, UNLESS OTHERWISE APPROVED BY THE ENGINEER.

TEMPORARY:

♦ ARTIFICIAL COVERINGS IN ACCORDANCE WITH SPECIFICATION SECTION 104.

◆ TURF AND SOD IN ACCORDANCE WITH SPECIFICATION SECTION 104. PERMANENT:

* ASPHALT OR CONCRETE SURFACE.

♦ SOD IN ACCORDANCE WITH SPECIFICATION SECTION 570 AND 575.

2.A.2.. STRUCTURAL PRACTICES:

IN THE SECTION 104 EROSION CONTROL PLAN, THE CONTRACTOR SHALL DESCRIBE THE PROPOSED STRUCTURAL PRACTICES TO CONTROL OR TRAP SEDIMENT AND OTHERWISE PREVENT THE DISCHARGE OF POLLUTANTS FROM EXPOSED AREAS OF THE SITE. SEDIMENT CONTROLS SHALL BE IN PLACE BEFORE DISTURBING SOIL UPSTREAM OF THE CONTROL. THE STRUCTURAL PRACTICES SHALL INCLUDE AT LEAST THE FOLLOWING, UNLESS OTHERWISE APPROVED BY THE ENGINEER:

TEMPORARY

- * INLET PROTECTION SYSTEM IN ACCORDANCE WITH DESIGN STANDARD 102 AND SPECIFICATION SECTION 104.
- * SEDIMENT BARRIER IN ACCORDANCE WITH DESIGN STANDARD 102 AND SPECIFICATION SECTION 104

PERMANENT:

- * ROADSIDE SWALES
- * SOD IN ROADSIDE SWALES.

2.B. STORMWATER MANAGEMENT

STORMWATER MANAGEMENT: THE PROPOSED WORK WILL NOT MODIFY THE EXISTING PATTERN OF THE STORMWATER MANAGEMENT SYSTEM.

2.C. OTHER CONTROLS

THE CONTRACTOR SHALL PRACTICE GOOD HOUSEKEEPING BY INSTITUTING A CLEAN ORDERLY, CONSTRUCTION SITE. THE FOLLOWING CONTROLS SHALL BE IMPLEMENTED TO FURTHER REDUCE POLLUTION AT THE PROJECT SITE:

2.C.1. DISCHARGE OF MATERIALS TO SURFACE WATERS:

NO CONSTRUCTION MATERIAL SHALL BE DISCHARGED TO WATERS OF THE STATE UNLESS AUTHORIZED BY A SECTION 404 PERMIT AND/OR THE STATE OF FLORIDA ENVIROMENTAL RESOURCE PERMIT. ALL CONSTRUCTION DEBRIS SHALL BE DISPOSED OF IN AN APPROVED UPLAND LOCATION. BUILDING MATERIAL SHALL NOT BE DISPOSED OF IN WETLANDS OR RURIED ON-SITE


2.C.2. OFF-SITE VEHICLE TRACKING AND DUST CONTROL:

IN THE SECTION 104 EROSION CONTROL PLAN, THE CONTRACTOR SHALL DESCRIBE THE PROPOSED METHODS OF MINIMIZING OFFSITE VEHICLE TRACKING OF SEDIMENTS AND GENERATING DUST. THE PROPOSED METHODS SHALL INCLUDE AT LEAST THE FOLLOWING, UNLESS OTHERWISE APPROVED BY THE ENGINEER:

- ✤ COVERING LOADED HAUL TRUCKS WITH TARPAULINS.
- * REMOVING EXCESS DIRT FROM ROADS DAILY.
- * USING ROADWAY SWEEPERS DURING DUST GENERATING ACTIVITIES SUCH AS EXCAVATION OPERATIONS.

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HOULDER IMPROVEMENTS



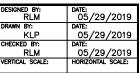

ROBERT L. MURRAY, P.E. P.E. NO: 35826 HOLE MONTES INC. 6200 WHISKEY CREEK DRIVE FORT MYERS, FL. 33919 CERTIFICATE OF AUTHORIZATION NO.1772

STORMWATER OLLUTION PREVENTION	reference no. 18081	drawing no. SPPPN—1
PLAN NOTES	project no. 2018081	sheet no. 19
FINAL PLANS 10/23/19		

2C3 WASTE DISPOSAL

THE CONTRACTOR SHALL DEMONSTRATE THE PROPER DISPOSAL OF ALL CONSTRUCTION WASTE GENERATED WITHIN THE PROJECT LIMITS. WASTE MAY INCLUDE, BUT NOT BE LIMITED TO, VEGETATION FROM CLEARING AND GRUBBING ACTIVITIES, PACKAGING MATERIALS, SCRAP BUILDING MATERIALS, LITTER FROM TRAVELING PUBLIC, SEWAGE FROM SANITARY FACILITIES, HERBICIDES AND PESTICIDES AND THEIR CONTAINERS, AND HYDROCARBON PRODUCTS. CONTRACTOR SHALL DESIGNATE A WASTER COLLECTION AREA ON SITE AND DELINEATE THE AREA ON THE SWPPP SITE MAP

SANITARY/SEPTIC FACILITIES SHALL BE PROVIDED AND MAINTAINED IN A NEAT AND SANITARY CONDITION, FOR THE USE OF THE CONTRACTOR'S EMPLOYEES AS NECESSARY TO COMPLY WITH THE REQUIREMENTS AND REGULATIONS OF THE STATE AND LOCAL BOARDS OF HEALTH. A LICENSED SANITARY WASTE MANAGEMENT CONTRACTOR AS REQUIRED BY STATE REGULATIONS WILL COLLECT ALL SANITARY WASTE FROM THE PORTABLE UNITS.

THE CONTRACTOR WILL PROVIDE LITTER CONTROL AND COLLECTION WITHIN THE PROJECT LIMITS DURING CONSTRUCTION ACTIVITIES. CONTRACTOR WILL PROVIDE AN ADEQUATE NUMBER OF LITTER CONTAINERS WITH LIDS AT THE STAGING, STOCKPILE, AND FIELD OFFICE AREAS. WASTE COLLECTION WILL BE SCHEDULED SO THAT CONTAINERS ARE EMPTIED PRIOR TO OVERFLOW. SPILLED LITTER CONTAINERS WILL BE CLEANED UP IMMEDIATELY.

2.C.4. FERTILIZERS AND PESTICIDES:

IN THE SECTION 104 EROSION CONTROL PLAN, THE CONTRACTOR SHALL DESCRIBE THE PROCEDURES FOR APPLYING FERTILIZERS AND PESTICIDES. THE PROPOSED PROCEDURES SHALL COMPLY WITH APPLICABLE SUBSECTIONS OF SECTION 570 OF THE SPECIFICATIONS.

2.C.5 TOXIC SUBSTANCES:

IN THE SECTION 104 EROSION CONTROL PLAN, THE CONTRACTOR SHALL PROVIDE A LIST OF TOXIC SUBSTANCES THAT ARE LIKELY TO BE USED ON THE JOB AND PROVIDE A PLAN ADDRESSING THE GENERATION, APPLICATION, MIGRATION, STORAGE, AND DISPOSAL OF THESE SUBSTANCES.

2.D. APPROVED STATE AND LOCAL PLANS:

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3.0 MAINTENANCE:

IN THE SECTION 104 EROSION CONTROL PLAN, THE CONTRACTOR SHALL PROVIDE A PLAN FOR MAINTAINING ALL EROSION AND SEDIMENT CONTROLS THROUGHOUT CONSTRUCTION. THE MAINTENANCE PLAN SHALL AT A MINIMUM, COMPLY WITH THE FOLLOWING:

TEMPORARY EROSION PROTECTION AND SEDIMENT BARRIERS PROPOSED FOR PROJECT INCLUDE:

SEDIMENT BARRIER: MAINTAIN PER SECTION 104

INLET PROTECTION SYSTEM: MAINTAIN PER SECTION 104

4.0 INSPECTION

THE CONTRACTOR IS REQUIRED TO INSPECT ALL EROSION CONTROL FEATURES AT LEAST ONCE EVERY SEVEN CALENDAR DAYS AND WITHIN 24 HOURS OF THE END OF A STORM OF .50 INCH (12.7MM) OR GREATER. IN ADDITION, MAINTAIN ALL EROSION CONTROL FEATURES AS REQUIRED HEREIN AND AS SPECIFIED IN STATE AND/OR FEDERAL ENVIRO ENTAL REGULATORY PERMITS. THIS INCLUDES, BUT IS NOT LIMITED TO, THE DAILY REVIEW OF THE LOCATION OF SILT FENCES IN AREAS WHERE CONSTRUCTION ACTIVITIES HAVE CHANGED THE NATURAL CONTOUR AND DRAINAGE RUNOFF TO ENSURE THAT SILT FENCES ARE PROPERLY LOCATED FOR EFFECTIVENESS. FINDINGS AND CORRECTIVE ACTIONS TAKEN AS A RESULT OF THE INSPECTION.

THE CONTRACTOR SHALL SIGN EACH INSPECTION REPORT AND SUBMIT IT WEEKLY TO THE ENGINEER. THE CONTRACTOR SHALL COMPLETE ALL SWPPP INSPECTION REPORT FORMS REQUIRED FOR THE NPDES PERMIT. THE INSPECTOR MUST BE QUALIFIED THROUGH CERTIFICATION BY THE DEPARTMENT OF ENVIRO ENTAL PROTECTION'S FLORIDA STORMWATER, EROSION AND SEDIMENT CONTROL TRAINING AND CERTIFICATION PROGRAM FOR INSPECTORS AND CONTRACTORS. WHERE SITES HAVE BEEN PERMANENTLY STABILIZED, INSPECTIONS SHALL BE CONDUCTED AT LEAST ONCE EVERY MONTH. THE FOLLOWING ITEMS SHALL BE INSPECTED:

- * POINTS OF DISCHARGE TO WATERS OF THE UNITED STATES.
- * POINTS OF DISCHARGE TO MUNICIPAL SEPARATE STORM SEWER SYSTEMS.
- STORMWATER MANAGEMENT SYSTEMS.
- ✤ DISTURBED AREAS OF THE SITE THAT HAVE NOT BEEN FINALLY STABILIZED.
- ✤ AREAS USED FOR STORAGE OF MATERIALS THAT ARE EXPOSED TO PRECIPITATION.
- ✤ STRUCTURAL CONTROLS.
- * LOCATIONS WHERE VEHICLES ENTER OR EXIT THE SITE.

THE FDOT STORMWATER POLLUTION PREVENTION PLAN CONSTRUCTION INSPECTION REPORT (FORM #650-040-031) SHALL BE USED TO REPORT THE INSPECTION FINDINGS TO THE ENGINEER AND THE CONTRACTOR AS TO THE ABOVE REFERENCED SCHEDULE. IF CORRECTIVE ACTION IS NECESSARY, IT SHALL BE RECORDED ON THE INSPECTION REPORT. IT SHALL BE THE RESPONSIBILITY OF THE CONTRACTOR TO MAKE THE CORRECTION IMMEDIATELY.

5.0 NON-STORMWATER DISCHARGES:

IF CONTAMINATED SOIL OR GROUNDWATER IS ENCOUNTERED DURING CONSTRUCTION, THE CONTRACTOR IS TO CEASE OPERATIONS IN THAT AREA. THE CONTRACTOR SHALL CONTACT THE PROJECT ENGINEER WHO WILL NOTIFY THE DISTRICT IMPACT COORDINATOR.

IT IS THE CONTRACTOR'S RESPONSIBILITY TO DEVELOP A DEWATERING SYSTEM THAT PROVIDES PRETREATMENT OF EFFLUENT PRIOR TO DISCHARGE INTO ADJACENT SURFACE WATERS. THE CONTRACTOR'S DEWATERING METHOD MUST MEET ALL FEDERAL, STATE, AND LOCAL LAWS, RULES AND REGULATIONS CONCERNING THIS PRACTICE INCLUDING THE USE OF PERMITTED OUTFALL STRUCTURES. THIS SWPPP IS ONLY A PART OF THE SECTION 104 EROSION CONTROL PLAN. IT IS THE RESPONSIBILITY OF THE CONTRACTOR TO SUBMIT TO THE ENGINEER A HAZARDOUS MATERIALS CONTROL PLAN TO BE INCLUDED IN THE SECTION 104 CONTROL PLAN.

THE CONTRACTOR SHALL ALSO INCLUDE WITH THE SECTION 104 EROSION CONTROL PLAN THE LOCATIONS OF STAGING AREAS AND STOCKPILE YARDS AND STABILIZATION PRACTICES FOR THESE SITES. THE CONTRACTOR SHALL BE AWARE THAT MODIFICATION OF THE TRAFFIC CONTROL PLANS MAY REQUIRE THE CONTRACTOR TO MODIFY THE SWPPP. THE CONTRACTOR'S MODIFIED SWPPP MUST RECEIVE APPROVAL FROM THE ENGINEER PRIOR TO IMPLEMENTATION. THE CONTRACTOR IS RESPONSIBLE FOR SUBMITTING THE FOLLOWING ITEMS TO MPO IN ORDER FOR THE NPDES PERMIT TO

BE PROCESSED:

- SIGNED CONTRACTOR CERTIFICATION FORMS (2). 1
- CONSTRUCTION PLAN SHEETS THAT AE LISTED IN THE SWPPP (FULL SETS WILL NOT BE ACCEPTED). 2
- 3 HAZARDOUS MATERIALS SPILL CONTROL PLAN.

SIGNED STATEMENT THAT THE SWPPP INCLUDED IN THE CONTRACT AS PART OF THE SECTION 104 EROSION CONTROL 4 PLAN FOR THE PROJECT WILL BE IMPLEMENTED DURING THE CONSTRUCTION OF THE PROJECT. THE CONTRACTOR MAY ELECT TO SUBMIT A REVISED SWPPP THAT IS IN COMPLIANCE WITH THE STORMWATER REGULATIONS AT 40 CFR 122.26(B)(14) AND STATE WATER QUALITY STANDARDS.

5. STAGING AREA AND STOCKPILE LOCATIONS.

THIS INFORMATION SHOULD BE SUBMITTED TO THE ENGINEER THIRTY (30) DAYS PRIOR TO ANY CLEARING AND GRUBBING ACTIVITIES. NO SOIL DISTURBING ACTIVITIES CAN BE CONDUCTED UNTIL THE NPDES PACKAGE AND PERMIT HAS BEEN APPROVE AND ATTAINED.

6.0 CONTRACTOR SUBMITTAL:

IT IS THE RESPONSIBILITY OF THE CONTRACTOR TO DEVELOP AN EROSION CONTROL PLAN THAT PROVIDES A DETAILED DESCRIPTION OF ALL EROSION AND SEDIMENT CONTROLS, BEST MANAGEMENT PRACTICES, AND MEASURES THAT WILL BE IMPLEMENTED AT THE CONSTRUCTION SITE FOR EACH ACTIVITY IDENTIFIED IN SECTION 1.B. SEQUENCE OF MAJOR SOIL DISTURBING ACTIVITIES. CONTRACTOR IS RESPONSIBLE FOR PROVIDING TIMEFRAMES IN WHICH THE CONTROLS WILL BE IMPLEMENTED, MAINTAINED AND REMOVED. THIS INFORMATION SHALL BE KEPT AT THE PROJECT FIELD OFFICE IN ORDER FOR THE PROJECT BOE BE CONSIDERED IN COMPLIANCE WITH THE FDEP GENERIC PERMIT FOR STORMWATER DISCHARGE FROM LARGE AND SMALL CONSTRUCTION SITES.

THE CONTRACTOR IS RESPONSIBLE FOR ENSURING THE FOLLOWING ITEMS ARE ON SITE: 1. COPY OF THE STORMWATER POLLUTION PREVENTION PLAN WITH THE ORIGINAL CERTIFICATION SIGNATURES.

- 2. COPY OF THE CONTRACTOR'S EROSION CONTROL PLAN.

HAZARDOUS SPILL CONTROL PLAN WITH GUIDELINES ON CONTACTING THE 24-HOUR EMERGENCY RESPONSE PROGRAM FOR HAZARDOUS MATERIAL SPILLS. THIS SHALL INCLUDE COPIES OF DISCHARGE NOTIFICATIONS THAT HAVE OCCURRED WITHIN THE PROJECT LIMITS.

4. COMPLETED INSPECTION FORMS.

THE CONTRACTOR IS RESPONSIBLE FOR SUBMITTING THE FOLLOWING ITEMS TO FDEP IN ORDER FOR THE NPDES PERMIT TO BE PROCESSED:

FDEP FORM 62-621.300(4Xb) - NOTICE OF INTENT TO USE GENERIC PERMIT FOR STORMWATER DISCHARGE FROM LARGE AND SMALL CONSTRUCTION ACTIVITIES. THIS NOTICE OF INTENT SHALL BE SIGNED BY THE CONTRACTOR. 2. IT IS THE CONTRACTOR'S RESPONSIBILITY TO SUBMIT THE NOI TO FDEP NO LESS THAN 48-HOURS PRIOR TO THE START OF CONTRACTION. CONTRACTOR SHALL BE RESPONSIBLE FOR PROVIDING PROOF OF DATE TO THE PROJECT ADMINISTRATOR.

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STORMWATER	REFERENCE NO.	DRAWING NO.
DI LUTION PREVENTION	18081	SPPPN-1
	PROJECT NO.	SHEET NO.
PLAN NOTES	2018081	20
FINAL PLANS 10/23/19		

MAINTENANCE OF TRAFFIC NOTES

ROADWAY

- 1. THE MAINTENANCE OF TRAFFIC FOR THIS PROJECT SHALL BE IN ACCORDANCE WITH THE CURRENT EDITIONS OF THE FLORIDA D.O.T. DESIGN STANDARDS (600 SERIES), THE STANDARD FOR ROAD AND BRIDGE CONSTRUCTION, AND THE CURRENT EDITION OF THE MANUAL ON UNIFORM TRAFFIC CONTROL DEVICES (MUTCD). TRAFFIC CONTROL AND LANE CLOSURES (AS REQUIRED) SHALL BE IN ACCORDANCE WITH THE APPROPRIATE DESIGN STANDARDS TRAFFIC CONTROL THROUGH WORK ZONE INDEX.
- 2. THE CONTRACTOR SHALL SUBMIT COMPLETE TRAFFIC CONTROL PLANS FOR REVIEW AND APPROVAL BY THE ENGINEER NO LESS THAN 7 DAYS PRIOR TO CONSTRUCTION; TRAFFIC CONTROL PLANS SHALL BE PREPARED BY QUALIFIED PROFESSIONALS WHO HAVE COMPLETED A COURSE OF PREPARATION OF TRAFFIC CONTROL PLANS AND SHALL BE SIGNED BY A PROFESSIONAL ENGINEER (P.E.) REGISTERED IN THE STATE OF FLORIDA. ALL MAINTENANCE OF TRAFFIC RELATED COSTS SHALL BE INCLUDED UNDER PAY ITEM 102-1 EXCEPT FOR SPECIFIC MAINTENANCE OF TRAFFIC PAY ITEMS IDENTIFIED IN THE PLANS.
- 3. THE CONTRACTOR SHALL INSTALL CONSTRUCTION SIGNING PRIOR TO COMMENCEMENT OF CONSTRUCTION AND MAINTAIN SIGNING DURING ALL PHASES OF CONSTRUCTION.
- 4. THE ALTERATION OF TRAVEL WAYS TO CREATE A WORK ZONE SHALL NOT COMMENCE UNTIL ALL LABOR AND MATERIAL ARE READY FOR THE CONSTRUCTION IN THAT ZONE.
- 5. PUBLIC ACCESS TO BUSINESSES, RESIDENCES, SCHOOL AND SIDE STREETS MUST BE MAINTAINED AT ALL TIMES DURING CONSTRUCTION.
- 6. NOTIFICATION OF LANE CLOSURES OR TEMPORARY DETOURS SHALL BE ACCOMPLISHED 14 CALENDAR DAYS PRIOR TO CLOSURE OR DETOUR BY SUBMITTING THE REQUIRED LANE CLOSURE FORM, SKETCHES, CALCULATIONS AND OTHER DATA REQUIRED BY THE PROJECT ENGINEER.
- 7. THE CONTRACTOR SHALL MAKE PROVISIONS FOR THE REMOVAL OF STORM WATER FROM THE ROADWAY(S) DURING CONSTRUCTION. PROVISION SHALL BE SUBMITTED TO THE PROJECT ENGINEER FOR APPROVAL PRIOR TO USE. THE COST OF WATER REMOVAL SHALL BE INCLUDED IN PAY ITEM NO. 102-1, MAINTENANCE OF TRAFFIC (LUMP SUM).
- 8. THE CONTRACTOR SHALL REMOVE OR COVER ANY EXISTING OR PROPOSED SIGNS OR PAVEMENT MARKINGS WHICH CONFLICT WITH THE TRAFFIC CONTROL PLANS. WHEN THE CONFLICT NO LONGER EXISTS, THE CONTRACTOR SHALL RESTORE THE SIGNS OR PAVEMENT MARKINGS TO THEIR ORIGINAL POSITION. EXISTING PAVEMENT MARKINGS SHALL BE REMOVED BY MILLING, GRINDING OR BY OTHER METHODS APPROVED BY THE PROJECT ENGINEER. USE OF BLACK PAINT TO COVER EXISTING PAVEMENT MARKINGS IS PROHIBITED. THE COST OF SIGN REMOVAL AND RESTORING, PAVEMENT MARKING REMOVAL AND RESTORING SHALL BE INCLUDED IN PAY ITEM NO. 102-1, MAINTENANCE OF TRAFFIC (LUMP SUM).
- 9. THE CONTRACTOR SHALL FURNISH PORTABLE CHANGEABLE MESSAGE SIGNS (PCMS). MESSAGES FOR THE PCMS SHALL BE AS INDICATED AS DIRECTED BY THE ENGINEER. THE PCMS SHALL BE IN PLACE ONE WEEK PRIOR TO THE START OF ANY WORK ITEMS AFFECTING EXISTING VEHICULAR AND PEDESTRIAN TRAVELWAYS. PCMS SHALL BE REMOVED TWO CALENDAR WEEKS AFTER THE START OF THE ABOVE REFERENCED WORK ITEMS, EXCEPT DURING NIGHT WORK OR, AS OTHERWISE DIRECTED BY THE PROJECT ENGINEER. PCMS SHALL BE PAID FOR UNDER ITEM 102-1, MAINTENANCE OF TRAFFIC (LUMP SUM).

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ROADWAY, CONT.

- 10. PEAK HOURS ARE CONSIDERED TO BE BETWEEN 6 AM TO 7:30 AM AND 1:00 PM TO 2:30 PM MONDAY THROUGH FRIDAY DUE TO SCHOOL OPERATIONS. LANE CLOSURES SHALL BE ALLOWED ONLY DURING OFF-PEAK HOURS. ANY LANE CLOSURES BETWEEN 7:30 AM TO 1:00 PM AND 2:30 PM TO 8:00 PM, REQUIRE 24 HOUR NOTICE TO THE VILLAGE AND SCHOOL ADMINISTRATION.
- 11. THE CONTRACTOR SHALL USE A STREET SWEEPER (USING WATER) OR OTHER EQUIPMENT CAPABLE OF CONTROLLING AND REMOVING DUST. APPROVAL OF THE USE OF SUCH EQUIPMENT IS CONTINGENT UPON ITS DEMONSTRATED ABILITY TO DO WORK. CLEANING AND SWEEPING IS TO BE INCLUDED IN PAY ITEM NO. 102-1.

DROP OFFS AND ABOVE GROUND HAZARDS:

- 1. AT THE END OF EACH WORK PERIOD, ANY DROP OFF IN THE AREA ADJACENT TO THE TRAVEL WAY SHALL BE BACKFILLED IN ACCORDANCE WITH STANDARD INDEX NO. 600, OR SHALL BE OTHERWISE PROTECTED WITH TEMPORARY BARRIER WALL AT CONTRACTORS EXPENSE. TEMPORARY IMPACT ATTENUATORS MAY BE REQUIRED DEPENDING ON HOW THE CONTRACTOR ALIGNS THE ENDS OF THE BARRIER WALLS.
- 2. CONTRACTOR SHALL PROVIDE PROTECTION FROM ABOVE GROUND HAZARDS IN THE AREA ADJACENT TO THE TRAVELWAY. PROTECTION FROM ABOVE GROUND HAZARDS SHALL BE AT THE CONTRACTORS EXPENSE.

UTILITIES:

1. THE CONTRACTOR IS RESPONSIBLE FOR COORDINATING WITH THE UTILITY OWNERS IN DETERMINING SUITABLE UTILITY RELOCATIONS/ ADJUSTMENTS THAT WILL BE REQUIRED TO ACCOMMODATE THE MAINTENANCE OF TRAFFIC. THE COST FOR CONTRACTOR COORDINATING WITH THE UTILITY OWNERS SHALL BE PAID UNDER PAY ITEM 102-1, MAINTENANCE OF TRAFFIC (LUMP SUM).

TEMPORARY PAVEMENT

1. WHERE TEMPORARY PAVEMENT IS REQUIRED IT SHALL CONSIST OF OPTIONAL BASE GROUP 9, TYPE B-12.5 (ONLY). THE TEMPORARY PAVEMENT SHALL BE CONSTRUCTED ON A FIRM, UNYIELDING, WELL COMPACTED SUBGRADE. THE COST OF THE TEMPORARY PAVEMENT, INCLUDING THE WELL COMPACTED SUBGRADE, REMOVAL AND DISPOSAL OF THE TEMPORARY PAVEMENT, TO BE INCLUDED IN PAY ITEM 102-1, MAINTENANCE OF TRAFFIC (LUMP SUM).

WORK ZONE LIMITS:

1. THE CONTRACTOR WILL NOT BE ALLOWED TO OPEN UP TRENCHES THAT CANNOT BE BACKFILLED DURING THE SAME WORKING PERIOD WITHOUT THE APPROVAL OF THE PROJECT ENGINEER.

PEDESTRIAN, BICYCLES, & WHEELCHAIRS:

- 1. AT THE END OF EACH WORK PERIOD, ANY DROP OFF ADJACENT TO THE SUBJECT TRAVELWAYS SHALL BE BACKFILLED FLUSH WITH THE TRAVELWAY OR SHALL BE PROTECTED WITH BARRICADES, TEMPORARY BARRIER WALL, OR APPROVED HANDRAIL.
- THROUGHOUT THE PROJECT LIMITS, WHERE EXISTING PEDESTRIAN AND BICYCLE FACILITIES EXIST, CONTRACTOR SHALL MAINTAIN ACCOMMODATION. PROVISION FOR THE DISABLED MUST BE PROVIDED. THE TRAVELWAY SHALL BE A MINIMUM OF 5' WIDE, SMOOTH BUT NOT SLICK, WITH A WATERPROOF SURFACE.

3. PEDESTRIAN, BICYCLE, AND WHEELCHAIR TRAFFIC SHALL BE GUIDED AND MAINTAINED USING APPROVED WARNING LIGHTS, SIGNING AND CHANNELIZATION DEVICES FOR GUIDANCE. SUCH

PEDESTRIAN, BICYCLES, & WHEELCHAIRS, CONT.

- 4. CONTROL DEVICES SHALL BE INSPECTED AND MAINTAINED IN ACCORDANCE WITH FDOT SPECIFICATIONS AND THE MUTCD SECTIONS ON WORK ZONE TRAFFIC CONTROL.
- 5. THE CONTRACTOR IS RESPONSIBLE FOR PROVIDING A SAFE AND ADEQUATE WALKING SURFACE APPLICABLE TO THE AMERICANS WITH DISABILITIES ACT (ADA) FOR PEDESTRIANS. SAFE WALK ROUTES FOR ALL PEDESTRIANS AND TRANSIT USERS WITHIN THE VICINITY OF THE CONSTRUCTION ZONE SHALL BE MAINTAINED THROUGHOUT CONSTRUCTION. THIS INCLUDES SAFE WALK/ACCESS TO AND FROM EXISTING BUS STOPS AND TRANSIT VEHICLES IF THE CURRENT WALKING SURFACE AND ACCESS TO AND FROM TRANSIT VEHICLES AT BUS STOPS CAN NOT BE MAINTAINED, THEN A TEMPORARY ROAD-ROCK 4' WALK WAY SHALL BE CREATED. THE SAFE WALK ROUTE SHALL BE SEPARATED FROM THE CONSTRUCTION ACTIVITY BY THE 4' HIGH ORANGE CONSTRUCTION FENCE FOR THE ENTIRE LENGTH OF THE PROJECT OR THE LENGTH OF THE WALK ROUTE, WHICHEVER IS LESS.
- 6. PEDESTRIAN WALKWAYS SHOULD BE MAINTAINED FREE OF ANY OBSTRUCTIONS AND HAZARDS SUCH AS HOLES, DEBRIS, MUD, CONSTRUCTION EQUIPMENT, STORED MATERIALS, ETC. ANY HAZARDS NEAR OR ADJACENT TO WALKWAYS SHOULD BE CLEARLY DELINEATED.
- 7. WHERE SAFE PEDESTRIAN ACCESS/WALKWAYS CAN NOT BE PROVIDED, PEDESTRIANS SHOULD BE DIRECTED TO ALTERNATIVE ROUTES BY APPROPRIATE TRAFFIC CONTROL DEVICES. PEDESTRIAN, BICYCLE, AND WHEELCHAIR TRAFFIC SHALL BE GUIDED AND MAINTAINED (SPECIAL ATTENTION IS DIRECTED TO THE EXISTING BUS STOP LOCATION ACCESS) USING APPROVED WARNING LIGHTS, SIGNING, AND CHANNELIZATION DEVICES. SUCH CONTROL DEVICES SHALL BE INSTALLED AND MAINTAINED IN ACCORDANCE WITH THE MUTCD SECTIONS ON WORK ZONE TRAFFIC CONTROL FOR PEDESTRIANS AND CHAPTER 6D, PEDESTRIAN AND WORKER SAFETY.
- 8. IT SHALL BE THE RESPONSIBILITY OF THE CONTRACTOR TO INSTALL ANY NECESSARY PAVEMENT, ROAD ROCK, PAVEMENT MARKINGS AND SIGNAGE AND/ OR ANY PEDESTRIAN SIGNALIZATION AND/OR SIGNAL MODIFICATION TO ACCOMMODATE AN EXISTING OR ALTERNATE WALK ROUTE.
- 9. THE CONTRACTOR IS RESPONSIBLE FOR PROVIDING A SAFE AND ADEQUATE WALKING ROUTE FOR ALL SCHOOL STUDENTS WITHIN THE VICINITY OF THE CONSTRUCTION ZONE DURING THE TIMES STUDENTS ARE ARRIVING AT OR LEAVING SCHOOL. IF THE CURRENT WALKING SURFACE CAN NOT BE MAINTAINED, THEN A TEMPORARY ROAD ROCK 4' WALK WAY SHALL BE CREATED. THE SAFE WALK ROUTE SHALL BE SEPARATED FROM THE CONSTRUCTION ACTIVITY BY A 4' HIGH ORANGE CONSTRUCTION FENCE FOR THE ENTIRE LENGTH OF THE PROJECT OR THE LENGTH OF THE WALK ROUTE, WHICHEVER IS LESS.
- 10. ALL CONSTRUCTION EQUIPMENT AROUND ANY DESIGNATED CROSSWALK SHALL CEASE TO OPERATE DURING TIMES STUDENTS ARE ARRIVING OR LEAVING SCHOOL. ALL CONSTRUCTION EQUIPMENT ADJACENT TO A DESIGNATED WALK ROUTE SHALL CEASE OPERATING UNLESS SATISFACTORILY BARRICADED FROM THE WALK ROUTE.
- 11. IN THE CASE THAT A DESIGNATED CROSSING OR ANY PORTION OF THE DESIGNATED WALK ROUTE CAN NOT BE MAINTAINED, THEN THE CONTRACTOR SHALL NOTIFY THE OWNERS

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WILLIAMS ROAD TURN LANE & PAVED SHOULDER IMPROVEMENTS

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ROBERT L. MURRAY, P.E. P.E. NO.: 35826 HOLE MONTES, INC. 6200 WHISKEY CREEK DRIVE FORT MYERS, FL. 33919 CERTIFICATE OF AUTHORIZATION NO.1772 REPRESENTATIVE, A MINIMUM OF TEN (10) WORKING DAYS PRIOR TO CLOSING THAT ROUTE IN ORDER THAT AN ALTERNATE CROSSING/ROUTE CAN BE ESTABLISHED.

PEDESTRIAN, BICYCLES, & WHEELCHAIRS, CONT.

- 12. IT SHALL BE THE RESPONSIBILITY OF THE CONTRACTOR TO INSTALL ANY NECESSARY PAVEMENT, ROAD ROCK, PAVEMENT MARKINGS, SIGNAGE AND/OR PEDESTRIAN SIGNALIZATION AND/OR SIGNAL MODIFICATION TO ACCOMMODATE AN EXISTING OR ALTERNATE WALK CROSSING/ROUTE.
- 13. IT SHALL BE THE RESPONSIBILITY OF THE CONTRACTOR TO PROVIDE STATE CERTIFIED SCHOOL CROSSING GUARDS OR OFF DUTY POLICE OFFICERS TO CROSS STUDENTS AT ANY LOCATIONS OTHER THAN THOSE PREVIOUSLY DESIGNATED. THE CONTRACTOR MAY USE FLAGMEN, ONLY IF THEY ARE STATE CERTIFIED AS A SCHOOL CROSSING GUARD.
- 14. THIRTY (30) DAYS PRIOR TO THE BEGINNING OF CONSTRUCTION THE CONTRACTOR SHALL NOTIFY THE OWNERS REPRESENTATIVE TO ARRANGE A PRE-CONSTRUCTION – SCHOOL SAFETY MEETING.
- 15. IT SHALL BE THE CONTRACTOR'S RESPONSIBILITY TO NOTIFY THE OWNERS REPRESENTATIVE AND ASSIST TO ARRANGE A PRE-CONSTRUCTION - SCHOOL BUS MEETING. THIS MEETING IS TO DETERMINE ALL BUS ROUTES AND TO MAKE ANY NECESSARY ARRANGEMENTS FOR REROUTING. THIS MEETING SHALL INCLUDE THE OWNERS REPRESENTATIVE.
- 16. ALL COSTS FOR MAINTAINING PEDESTRIAN, TRANSIT, SCHOOL STUDENT, BICYCLES & WHEELCHAIRS ACCESS ARE INCLUDED IN PAY ITEM 102-1, MAINTENANCE OF TRAFFIC (LUMP SUM).

	REFERENCE NO.	DRAWING NO.
	18081	мот
MAINTENANCE OF TRAFFIC	PROJECT NO.	SHEET NO.
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GENERAL NOTES

- 1. ALL FINAL PAVEMENT MARKINGS SHALL BE THERMOPLASTIC PER FDOT STD. SPEC. SEC. 711-001, UNLESS OTHERWISE NOTED IN THE PLANS.
- 2. THE LOCATIONS OF THE UTILITIES SHOWN IN THE PLANS (INCLUDING THOSE DESIGNATED VV. Vh. AND VVh) ARE BASED ON LIMITED INVESTIGATION TECHNIQUES AND SHOULD BE CONSIDERED APPROXIMATE ONLY. THE VERIFIED LOCATIONS/ELEVATIONS APPLY ONLY AT THE POINTS SHOWN. INTERPOLATIONS BETWEEN THESE POINTS HAVE NOT BEEN VERIFIED.
- 3. SIGNS TO BE RELOCATED SHALL BE CONFIRMED TO HAVE REQUIRED REFLECTIVITY PER ASTM D4956.
- 4. UNLESS OTHERWISE NOTED, ALL EXISTING SIGNS SHALL REMAIN. THE CONTRACTOR SHALL BE RESPONSIBLE FOR REMOVING ALL SIGNS WHICH ARE TO BE REMOVED OR RELOCATED, AS NOTED IN THESE PLANS. SIGNS TO BE RELOCATED SHALL BE STORED AND PROTECTED DURING CONSTRUCTION, UNTIL SUCH TIME THEY ARE RE-INSTALLED AND THE PROJECT IS COMPLETE. ANY SIGNS DAMAGED DURING CONSTRUCTION SHALL BE REPLACED BY THE CONTRACTOR AT NO COST TO THE OWNER. SIGNS WHICH ARE NOT INTENDED TO BE RE-UTILIZED SHALL BE DELIVERED TO THE OWNERS REPRESENTATIVE.
- 5. SIGN ASSEMBLY LOCATIONS SHOWN ON THE PLANS WHICH ARE IN CONFLICT WITH LIGHTING, UTILITIES, LANDSCAPE, DRIVEWAYS, ETC., MAY BE ADJUSTED BY THE ENGINEER IN ACCORDANCE WITH DESIGN STANDARDS INDEX NO. 700-101. WARNING SIGN LOCATION CHANGES MUST BE APPROVED BY THE OWNER'S TRAFFIC ENGINEER.
- 6. FOR REMOVAL OF CONFLICTING STRIPING WATER BLASTING IS THE ONLY METHODS OF REMOVAL OF PAVEMENT MARKINGS ALLOWED.
- 7. ALL PAVEMENT MARKINGS SHALL BE IN ACCORDANCE WITH DESIGN STANDARDS INDEX 711-001, AND RPM'S TO BE PLACED PER INDEX 706-001.
- 8. A BLUE RPM SHALL BE PLACED IN THE CENTER OF THE NEAR LANE, ADJACENT TO FIRE HYDRANTS WITHIN THE PROJECT LIMITS.

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WILLIAMS ROAD
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SHOULDER IMPROVEMENTS

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TICAL SCALE:	HORIZONTAL SCALE



ROBERT L. MURRAY. P.E P.E. NO.: 35826 HOLE MONTES, INC. 6200 WHISKEY CREEK DRIVE FORT MYERS, FL. 33919 CERTIFICATE OF AUTHORIZATION NO.1772

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